


(OLD CEDAR RIDGE ELEMENTARY SCHOOL)


ROSETA ACCESSIBILITY, SAFETY AND SECURITY IMPROVEMENTS 1100 S ROSETA AVENUE, COLUMBIA, MO 60201

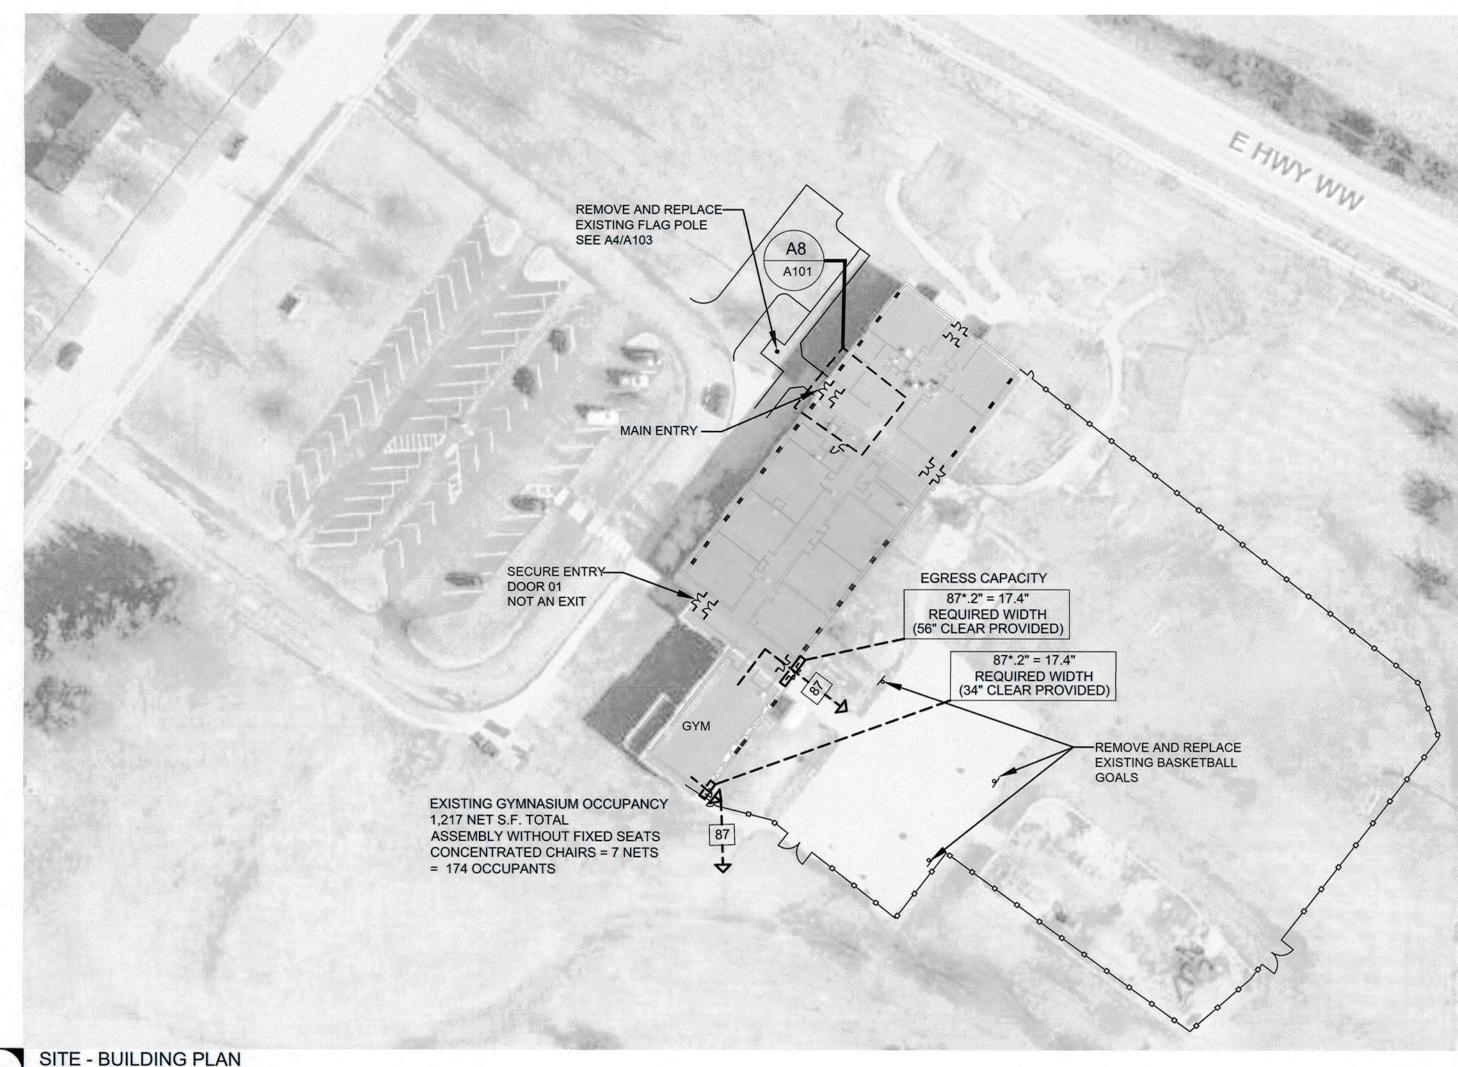

MASONRY CONCRETE SECTION CONCRETE **GYPSUM** SECTION BOARD **ELEVATION** GROUTED AREA OF: CMU/CAVITY/DOOR FRAME PLAN, SECTION PLAN, SECTION **ELEVATION** INSULATION SECTION SHINGLES **ELEVATION** CONTINUOUS PLAN, WOOD FRAMING SECTION PLAN, PLAN, **EXISTING** PLAN, BUILDING SECTION

LARGE SCALE


SMALL SCALE

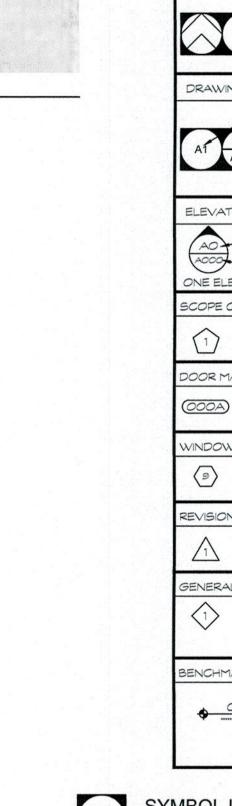

SCALE: NTS DRAWING BULLET WITH NORTH ARROW GRID REFERENCE DRAWING TITLE DRAWING BULLET WITHOUT NORTH ARROW GRID REFERENCE A2 DRAWING TITLE PAGE FIRST REFERENCED (IF APPLICABLE) ELEVATION BULLETS AN/ELEVATION DETAIL BULLET - GRID REFERENCE ONE ELEVATION - GRID REFERENCE SCOPE OF WORK BULLEWALL TYPE BULLET ECTION BULLET DOOR MARK BULLET | EQUIPMENT BULLET ALWAYS ON TOP WINDOW MARK BULLETACCESSORY BULLET NORTH ARROW REVISION NOTE BULL DLUMN LINE BULLETS GENERAL NOTE BULL BENCHMARK BULLET SPOT ELEV. BULLETS TC - TOP OF CURB TG - TOP OF GRADE TW - TOP OF WALL TP - TOP OF PAVING

GENERAL **BUILDING OCCUPANCY AND EGRESS PLAN GENERAL NOTES BOUNDARY & TOPOGRAPHIC SURVEY DEMOLITION PLAN** STORM SEWER DRAINAGE AREA MAP PLANS AND SCHEDULES **ELEVATIONS AND DETAILS** SECTIONS AND DETAILS MEP2 SITE UTILITIES PLAN **EP100 POWER PLAN EL100 LIGHTING PLAN** LIST OF DRAWINGS



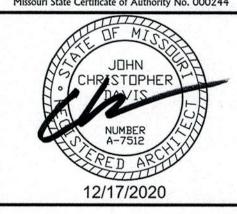

P1/2016 Projects/201621.19 CPS Dakland Middle School/Images/LDGD/CPS_LogoB.ti


ROSETA AVENUE LEARNING CENTER ACCESSIBILITY, SAFETY AND SECURITY **IMPROVEMENTS** 1100 S ROSETA AVENUE Columbia, MO 65201

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	g Title: ER SHEET		
No.	Revisions:		Date:

12/17/2020


SYMBOL LEGEND SCALE: NTS


12/14/2020

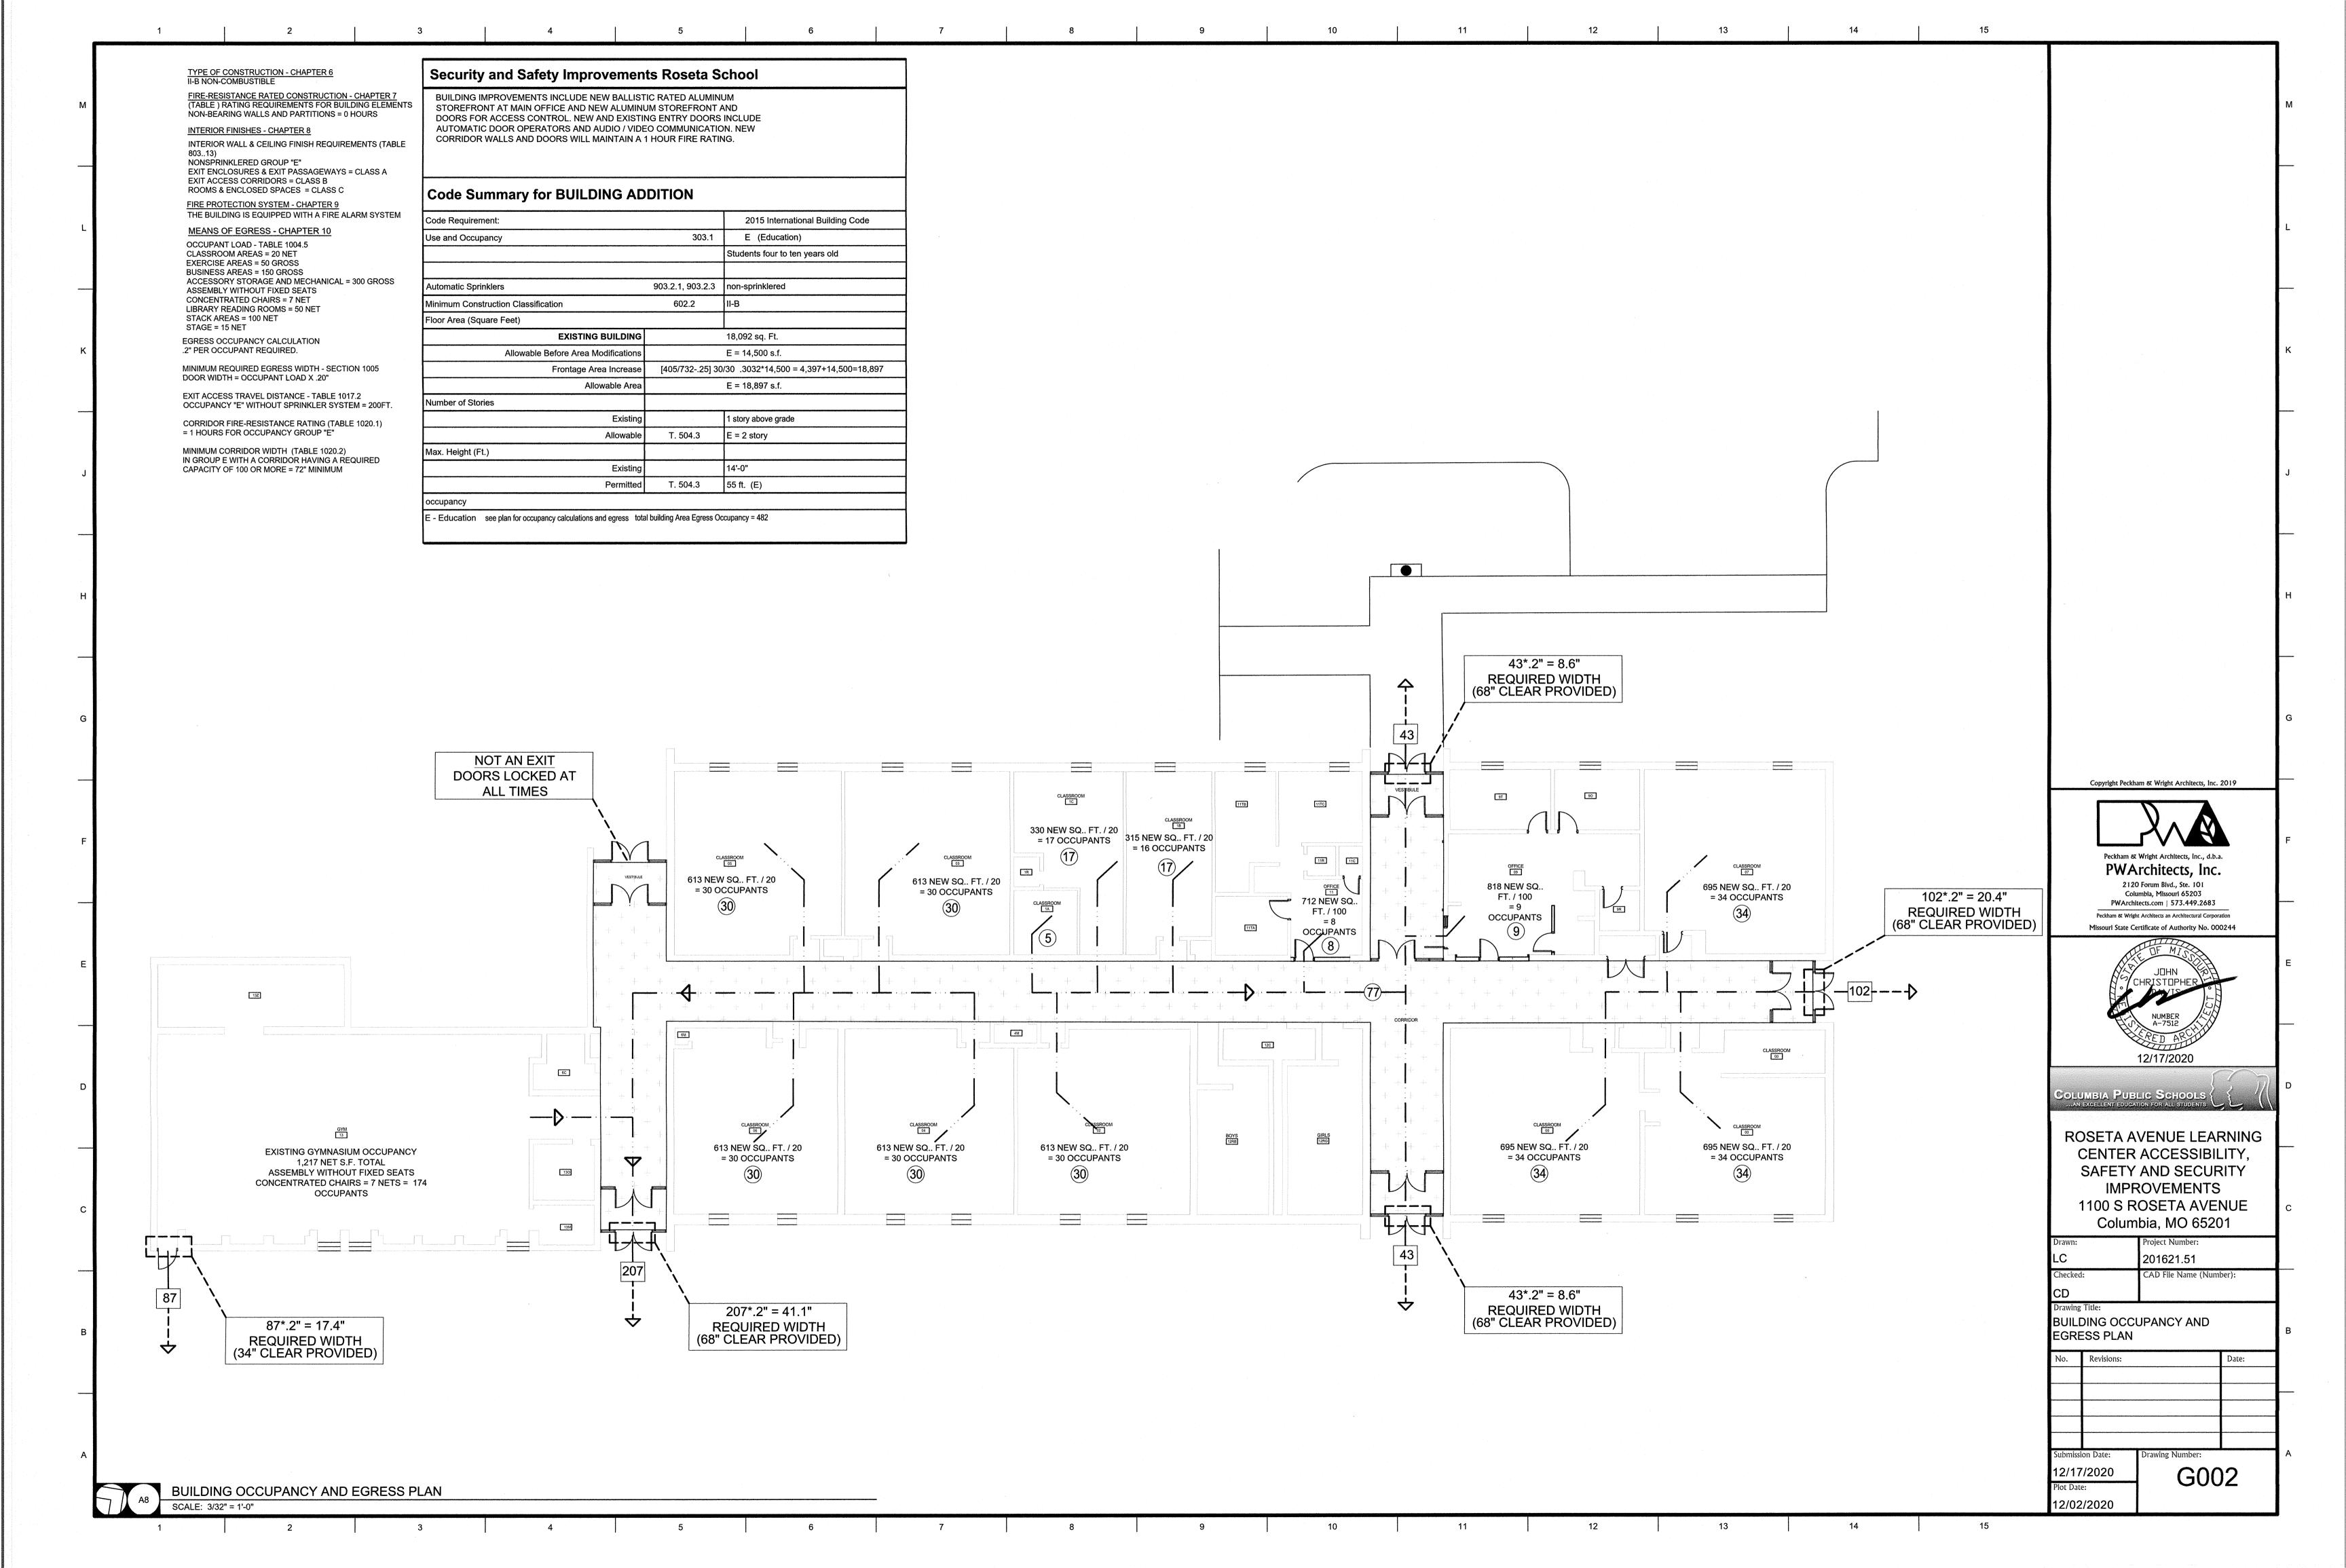

ROSETA AVENUE LEARNING CENTER ACCESSIBILITY, SAFETY AND SECURITY IMPROVEMENTS ²

BOONE COUNTY, MISSOURI SITE PLAN JUNE 25, 2020 REVISED: DECEMBER 17, 2020

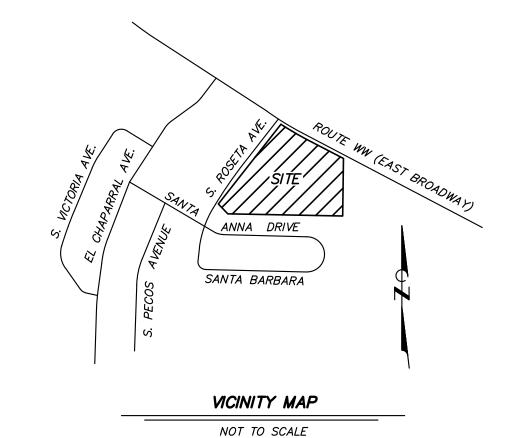

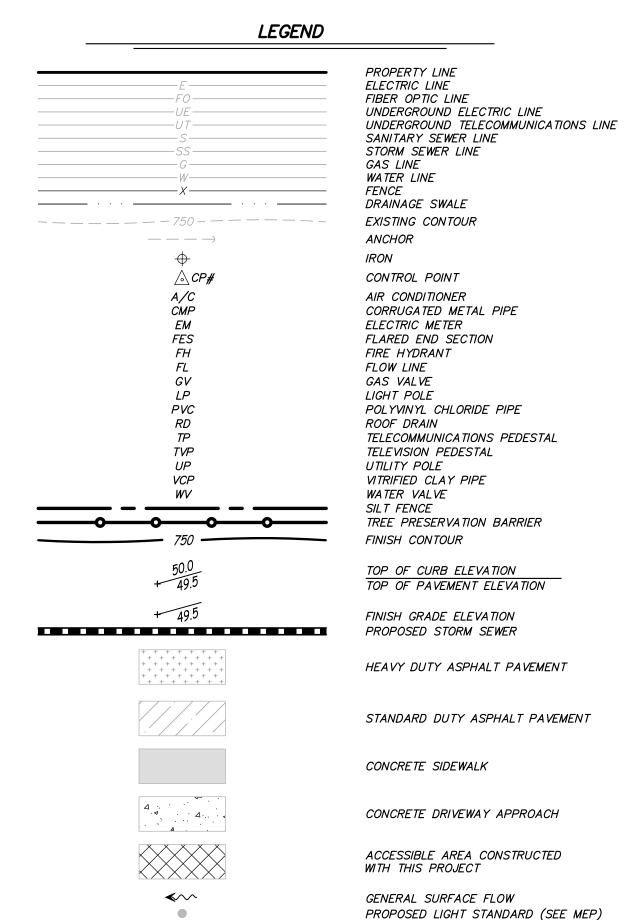

PROPERTY DESCRIPTION

TRACT DESCRIBED BY DEED RECORDED IN BOOK 450 PAGE 437

FLOODPLAIN NOTE

THIS PROPERTY IS LOCATED IN ZONE "X" AREAS DETERMINED TO BE OUTSIDE THE 0.2% ANNUAL CHANCE FLOODPLAIN, AS SHOWN BY FLOOD INSURANCE RATE MAP NUMBER 29019C0292E, DATED APRIL 17, 2019.

UTILITY NOTES

THE LOCATIONS, SIZES, AND MATERIAL TYPES OF UNDERGROUND UTILITIES INDICATED ON THE PLAT, NOT VISIBLE OR APPARENT FROM THE SURFACE, ARE SHOWN IN THEIR APPROXIMATE LOCATIONS FROM A MISSOURI ONE CALL SYSTEM LOCAIE, OR UTILITY COMPANY RECORDS AND WERE NOT VERIFIED IN THE FIELD. UNDERGROUND UTILITY SERVICES TO BUILDINGS WERE NOT LOCATED.

PUBLIC WATER SUPPLY DISTRICT NO. 9 391 RANGELINE ROAD COLUMBIA, MISSOURI 65201 CONTACT: ROGER BALLEW 573-474-9521 4" LINE ALONG WEST SIDE OF ROSETTA DRIVE 12" LINE ALONG NORTH SIDE OF STATE ROUTE WW

BOONE ELECTRIC COOPERATIVE 1413 RANGE LINE STREET

COLUMBIA, MISSOURI 65201 CONTACT: ANDREW PETRI 573-441-7243 AS SHOWN

AMEREN MISSOURI

2001 MAGUIRE BOULEVARD COLUMBIA, MISSOURI 65201 CONTACT: TRENT SNODGRASS 573-876-3063 3" PLASTIC LINE ALONG SOUTH SIDE OF STATE ROUTE WW

TELECOMMUNICATIONS CENTURYI INK 625 E. CHERRY STREET

COLUMBIA, MISSOURI 65201 CONTACT: DAVID ROBERTS 573-886-3503

MEDIACOM *1211 WILKES BOULEVARD* COLUMBIA, MISSOURI 65201

CONTACT: BOB BONER 573-443-1536 CITY OF COLUMBIA WATER & LIGHT DEPARTMENT P.O. BOX 6015 COLUMBIA, MISSOURI 65205

CONTACT: ERIC WORTS 573-874-6382

OVERHEAD SERVICE FROM UTILITY POLE ALONG HWY WW TO NORTH SIDE OF BUILDING SANITARY SEWER

BOONE COUNTY REGIONAL SEWER DISTRICT 1314 N. SEVENTH STREET COLUMBIA, MISSOURI 65201 CONTACT: TOM RATERMANN 573-443-2774

all BEFORE you DIG TOLL FREE -800-DIG-RITE MISSOURI ONE-CALL SYSTEM, INC.

PROPERTY OWNER

COLUMBIA PUBLIC SCHOOLS 1818 WEST WORLEY STREET COLUMBIA, MISSOURI 65203 PHONE: 573-214-3400

ZONING NOTE

THIS PROPERTY IS ZONED R-M, MODERATE DENSITY RESIDENTIAL

SURVEY ASSURANCE NOTE

SURVEY CONTROL POINTS PRIOR TO CONSTRUCTION. CONTACT REPRESENTATIVES OF ENGINEERING SURVEYS & SERVICES IMMEDIATELY IF

PARKING NOTE

REQUIRED PARKING

12 CLASSROOMS AT 2 SPACES/CLASSROOM = 24 SPACES 8,747 SF COMMON AREAS AT 1 SPACE/300 SF = 29 SPACES TOTAL REQUIRED = 53 SPACES

PROVIDED PARKING STANDARD PARKING ACCESSIBLE PARKING

= 3 SPACES TOTAL PROVIDED = 56 SPACES

= 53 SPACES

STORMWATER MANAGEMENT NOTE

ROSETA ELEMENTARY SCHOOL (JUNE 2020)					
Total Site Impervious Total Additional Impervi			Total Additional Impervious		
Allowed before			Allowed for Future Projects		
Total Existing Site	Stormwater	Total Proposed	before Stormwater		
Impervious	Requirements Apply	Site Impervious	Requirements Apply		
(SF)	(SF)	(SF)	(SF)		
73, 852	76,852	73,924	2,928		

Note: Boone County allows up to 3,000 sf of additional impervious area to a site for edevelopment before stormwater quality and detention requirements apply

BENCH MARK

- MISSOURI DEPARTMENT OF TRANSPORTATION VRS NETWORK, BASE STATION

- CHISELED SQUARE ON THE NORTHEAST CORNER OF TRANSFORMER PAD ON THE EAST SIDE OF ROSETTA SCHOOL. ELEVATION = 799.20

TBM 2 - CHISELED SQUARE ON THE BASE OF CONCRETE STEPS LOCATED AT THE

TBM 3 - CHISELED SQUARE AT NE CORNER OF CONCRETE SIDEWALK AT WEST SIDE (DRIVE OPPOSITE WEST ENTRANCE TO ROSETTA SCHOOL. ELEVATION = 797.53

SURVEY CONTROL POINTS

MODIFIED STATE PLANE COORDINATES NAD 83, MISSOURI CENTRAL ZONE, NAVD 88, U.S. SURVEY FEET						
POINT #	<u>NORTH</u>	<u>EAST</u>	<u>ELEVATION</u>	<u>DESCRIPTION</u>		
CP1	1130146.41	1705248.71	791.25	IRON		
CP5	1129822.80	1705054.13	789.80	IRON		

1705635.30

1705443.54

794.60


1130032.26

1129712.95

SHEET INDEX


	COVER SHEET
CO.02	GENERAL NOTES
V1.01	BOUNDARY & TOPOGRAPHIC SURVEY
C1.01	DEMOLITION PLAN
C2.01	OVERALL SITE PLAN
C3.01	SITE PLAN
<i>C3.02</i>	SITE PLAN — ACCESSIBLE AREAS
C4.01	GRADING & DRAINAGE PLAN
C4.02	GRADING DETAILS
C5.01	STORM SEWER PROFILES
C6.01	EROSION CONTROL PLAN
<i>C7.01–C7.03</i>	SITE DETAILS
C8.01	RIGHT-OF-WAY DETAILS
C9.01-C9.02	STORM SEWER DETAILS
C10.01-C10.02	EROSION CONTROL DETAILS
C11.01	STORM SEWER DRAINAGE AREA MAP
L1.01-L1.02	LANDSCAPE PLAN

ROSETA AVENUE LEARNING CENTER ACCESSIBILITY SAFETY AND SECURITY IMPROVEMENTS

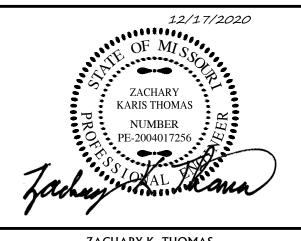

PROFESSIONAL ENGINEER



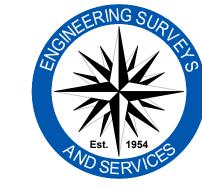


Engineering Surveys & Services 1113 Fay Street, Columbia, Missouri 65201 573 - 449 - 2646 | www.ess-inc.com Missouri Engineering Corporation # 2004005018



ES&S JOB NO. 14646

PWArchitects, Inc.

2120 Forum Blvd., Ste. 101 Columbia, Missouri 65203 PWArchitects.com | 573.449.2683 Peckham & Wright Architects an Architectural Corporation Missouri State Certificate of Authority No. 000244

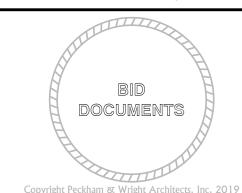

Columbia Public Schools { **ROSETA AVENUE LEARNING**

CENTER ACCESSIBILITY, ② SAFETY AND SECURITY **IMPROVEMENTS** 1100 S ROSETA AVENUE


COLUMBIA, MO 65201				
Drawn:	Project Number:			
BR	201621.51			
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ZKT				
Drawing Title:				
COVER SHEET				


No.	Revisions:	Date:
1	OWNER COMMENTS	10/26/20
2	OWNER COMMENTS	12/17/20
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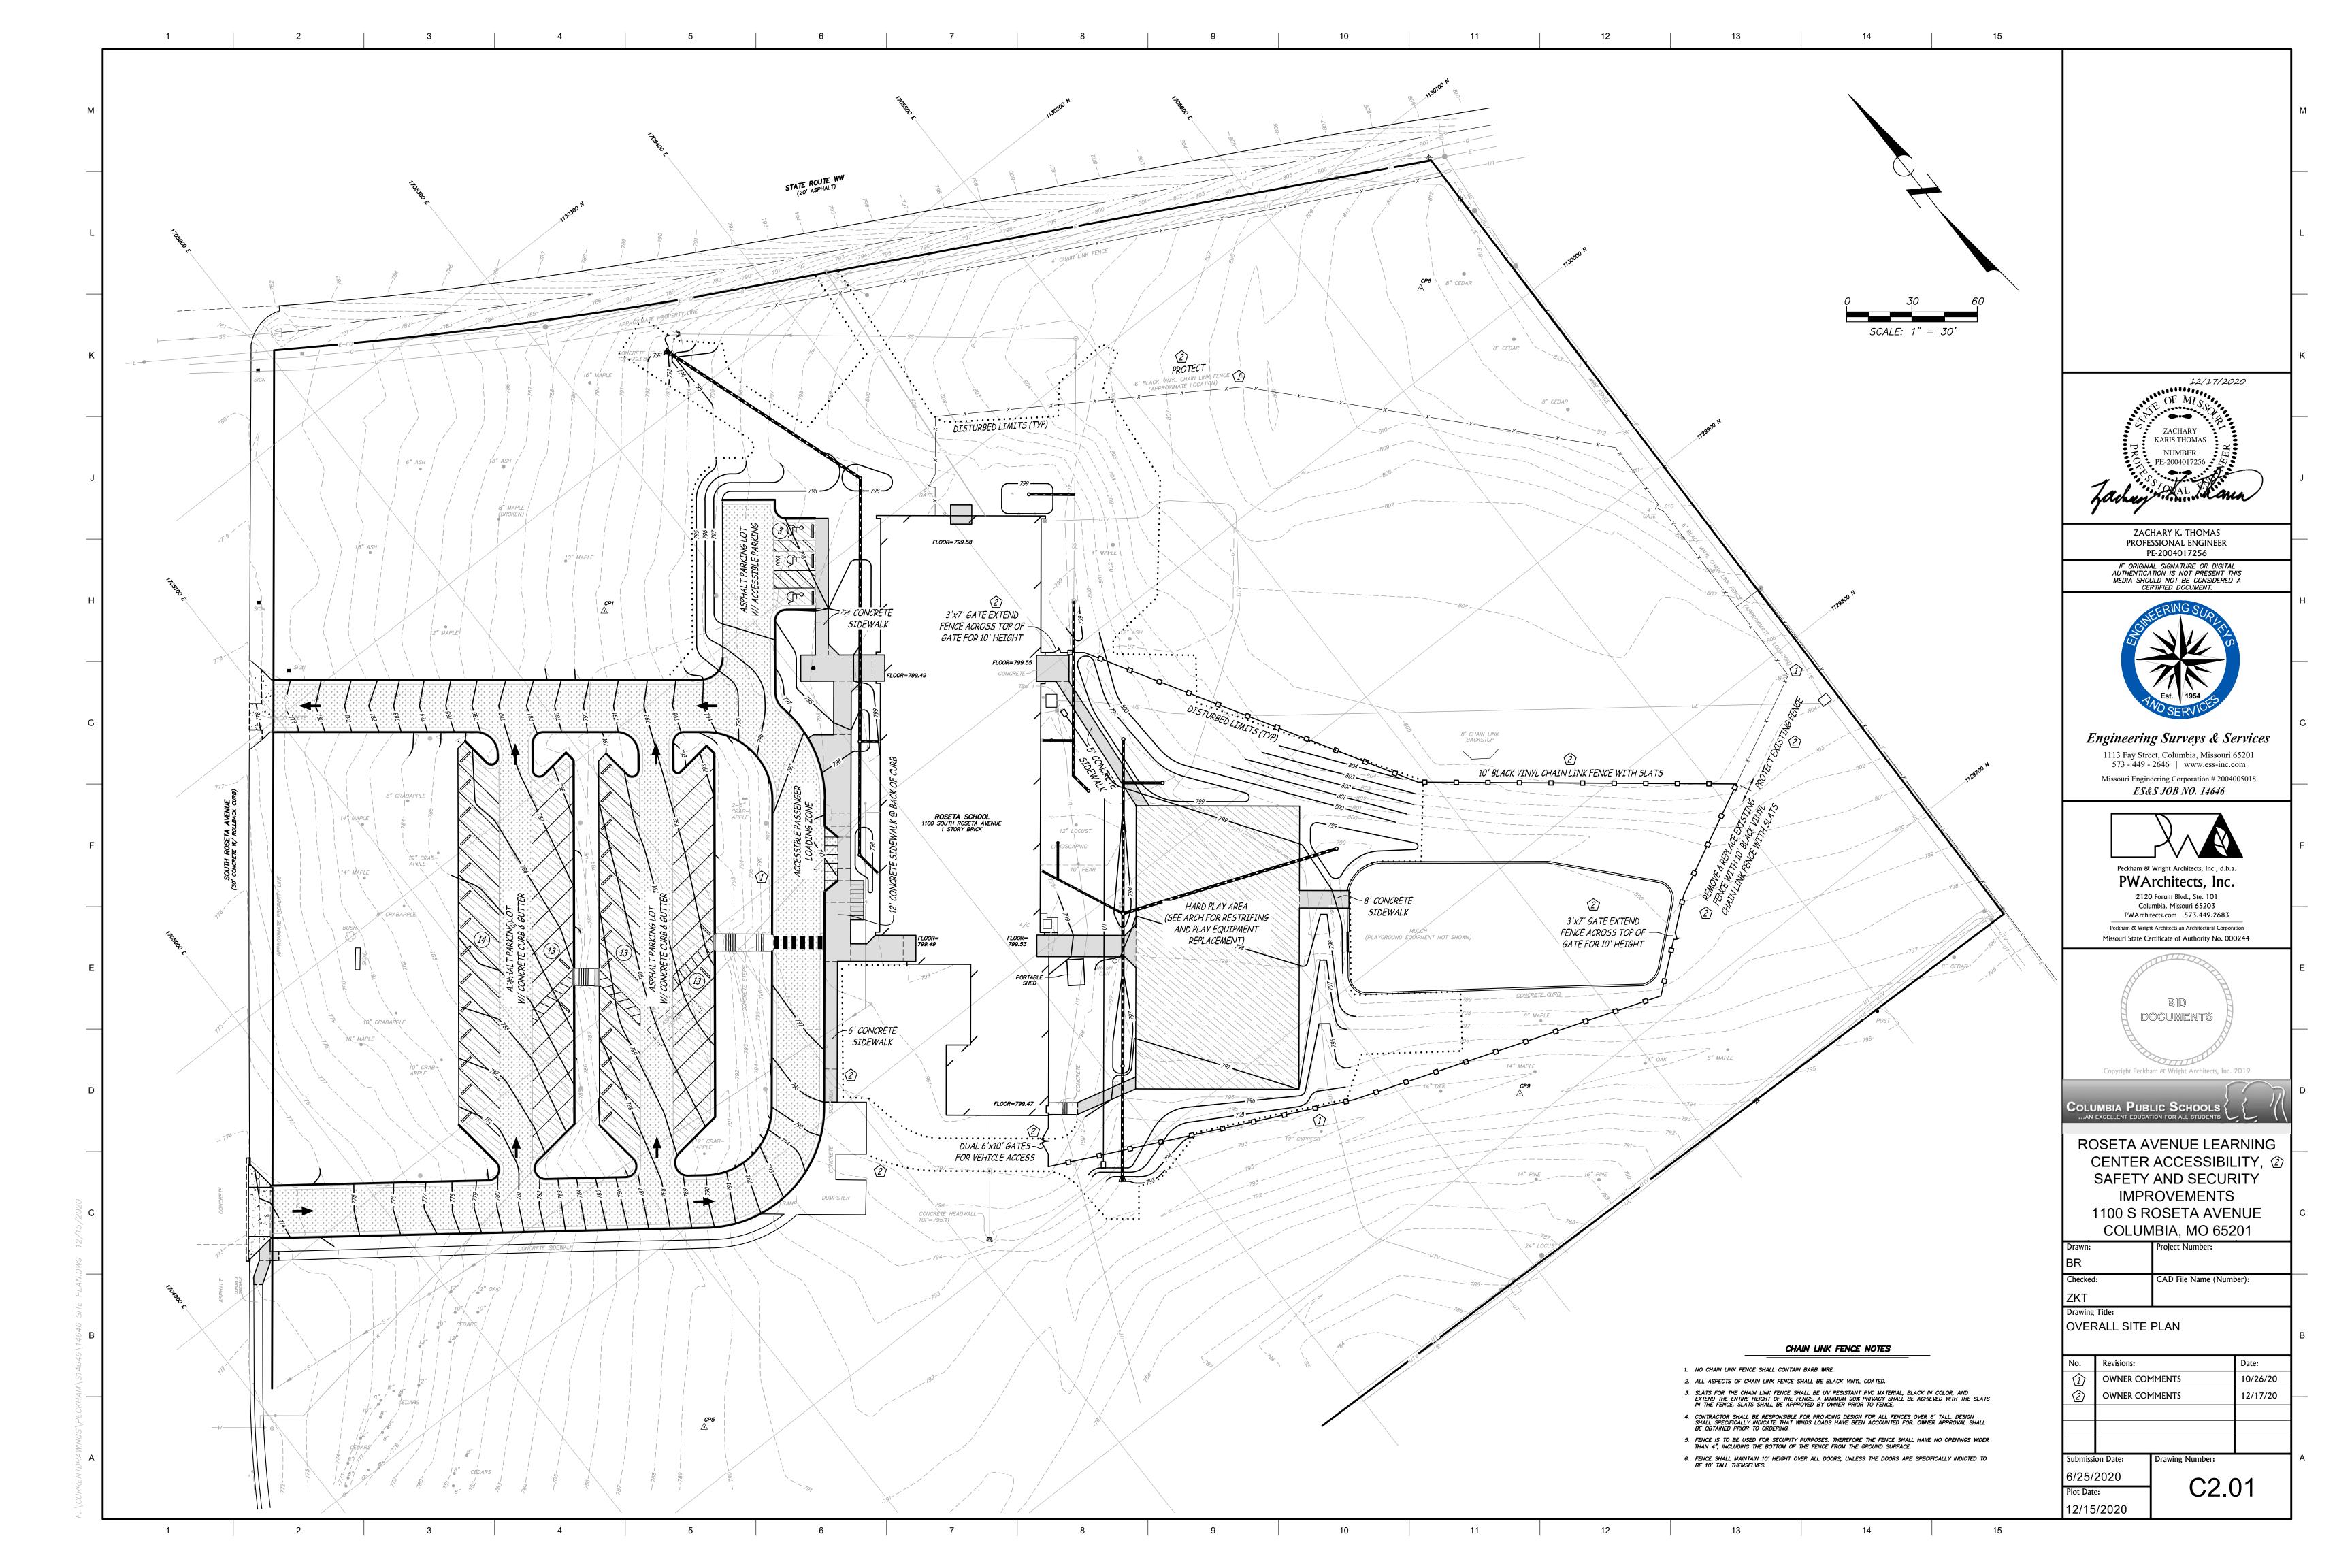
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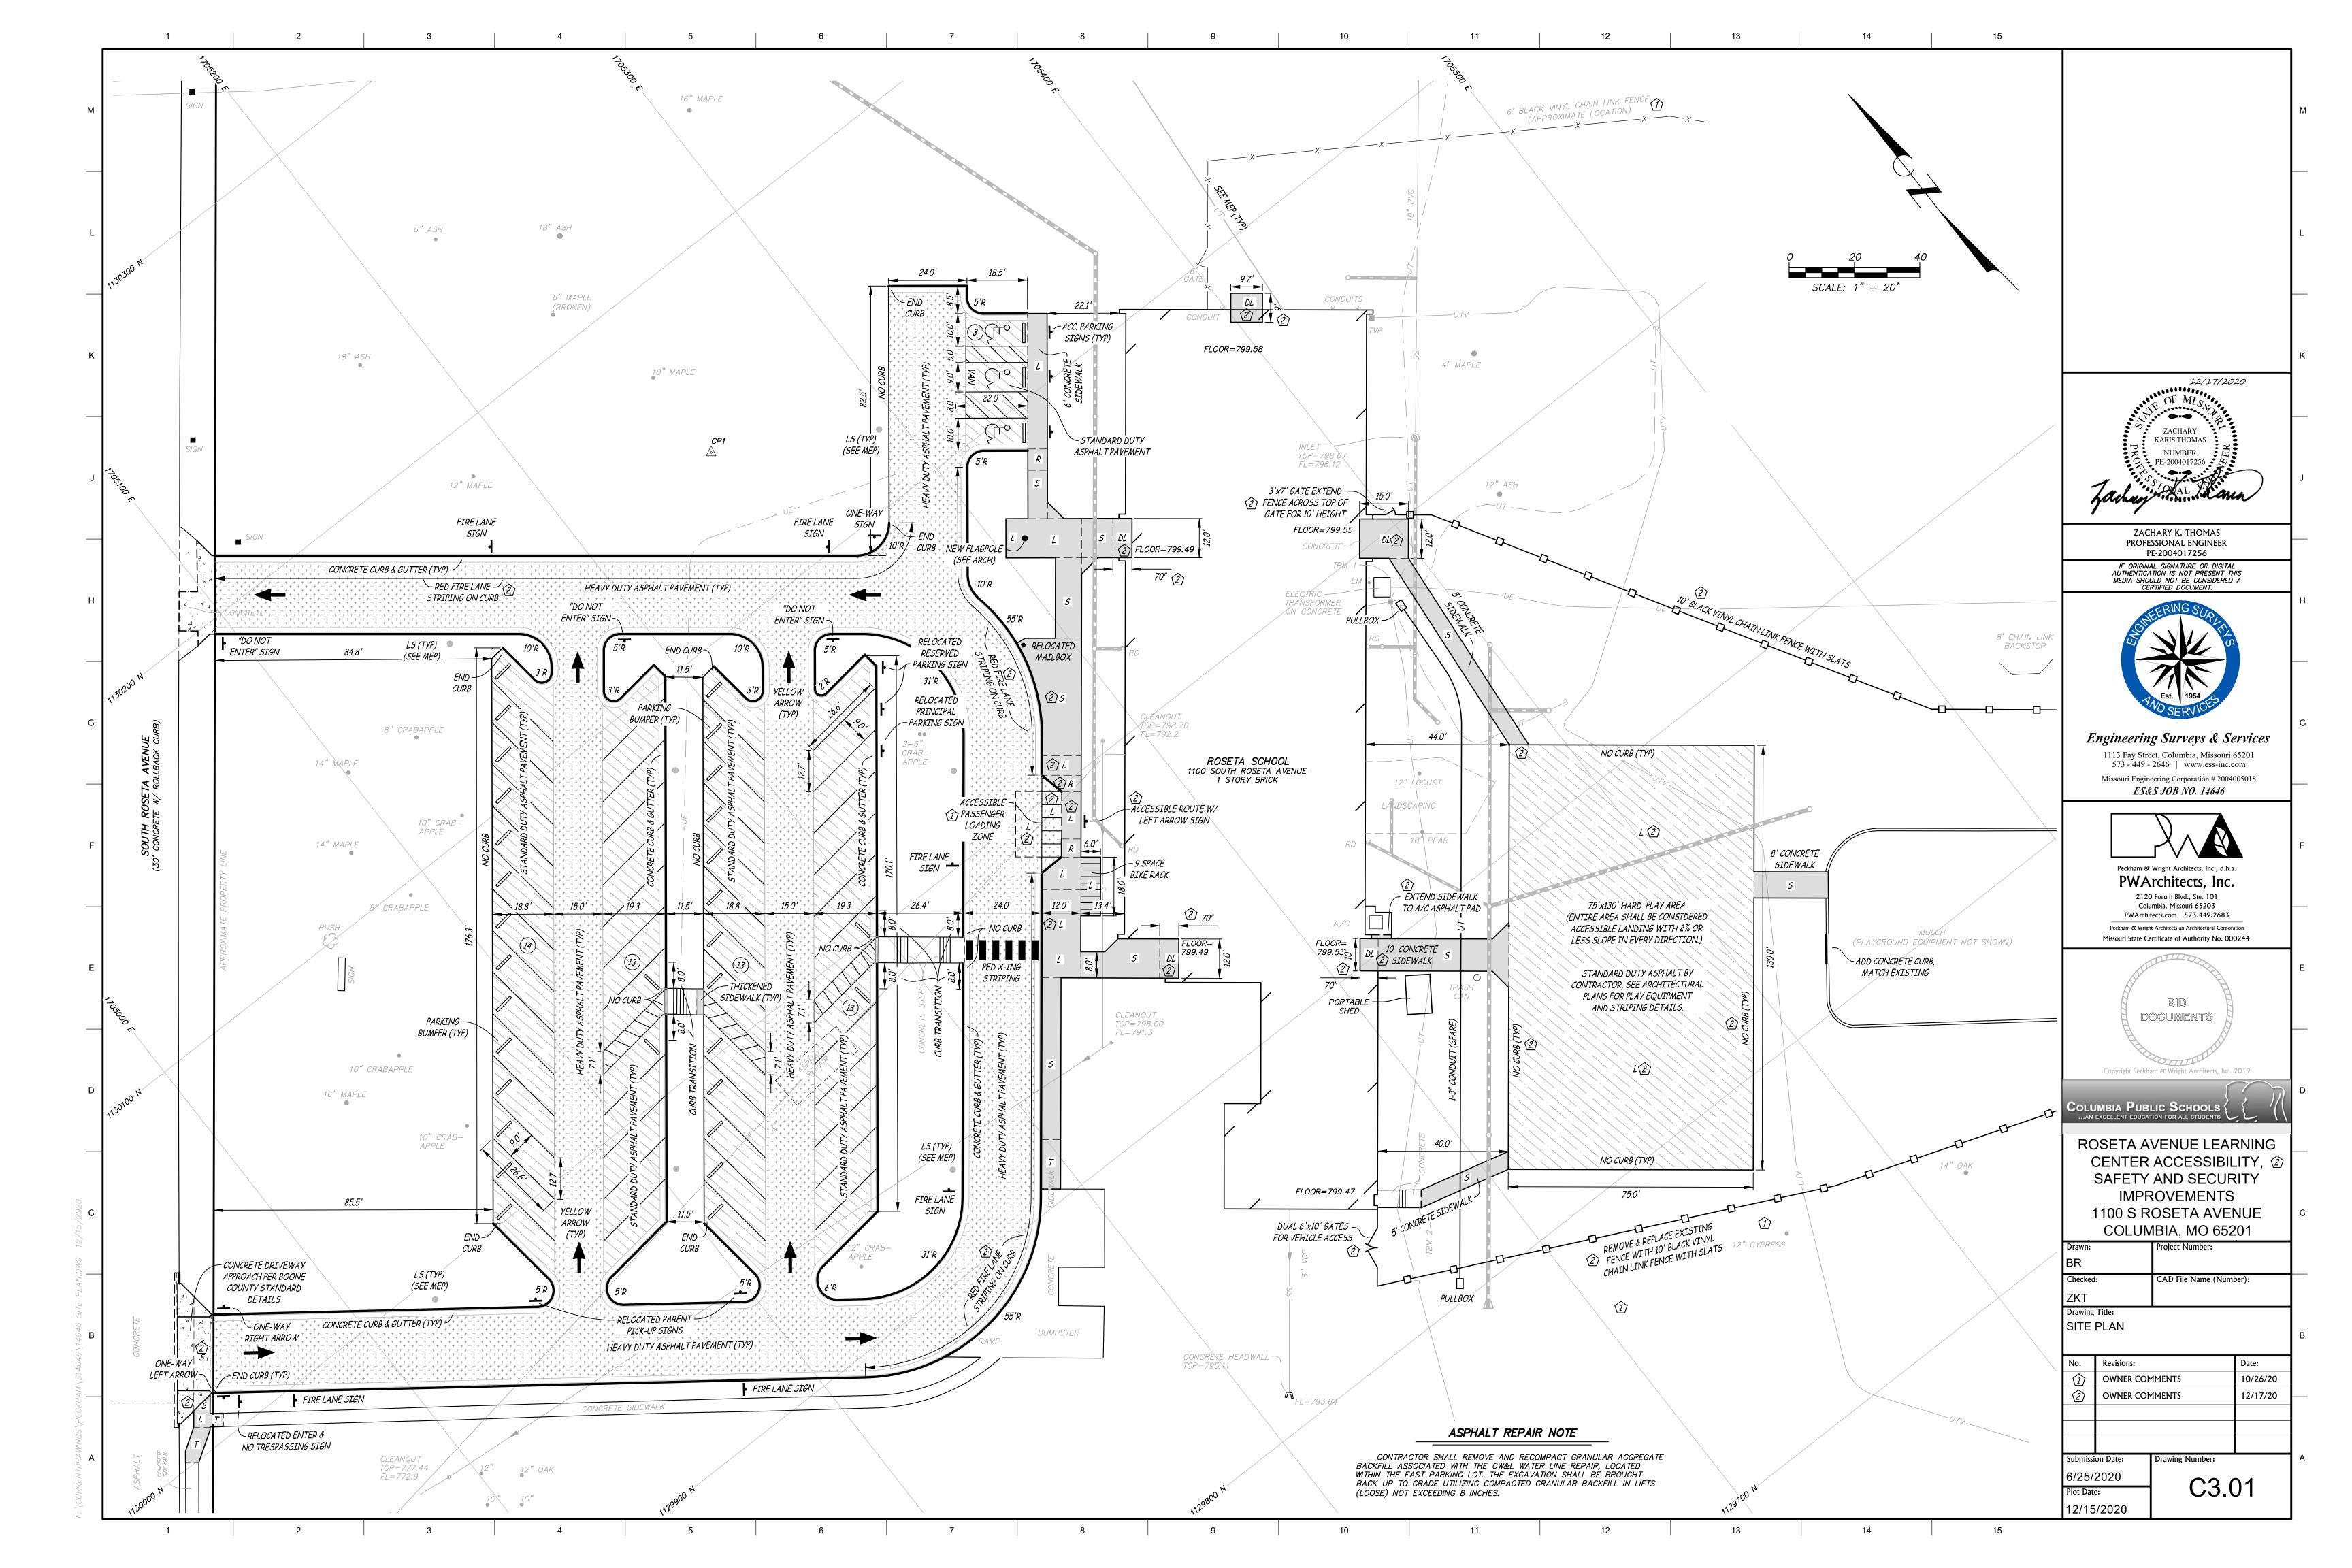
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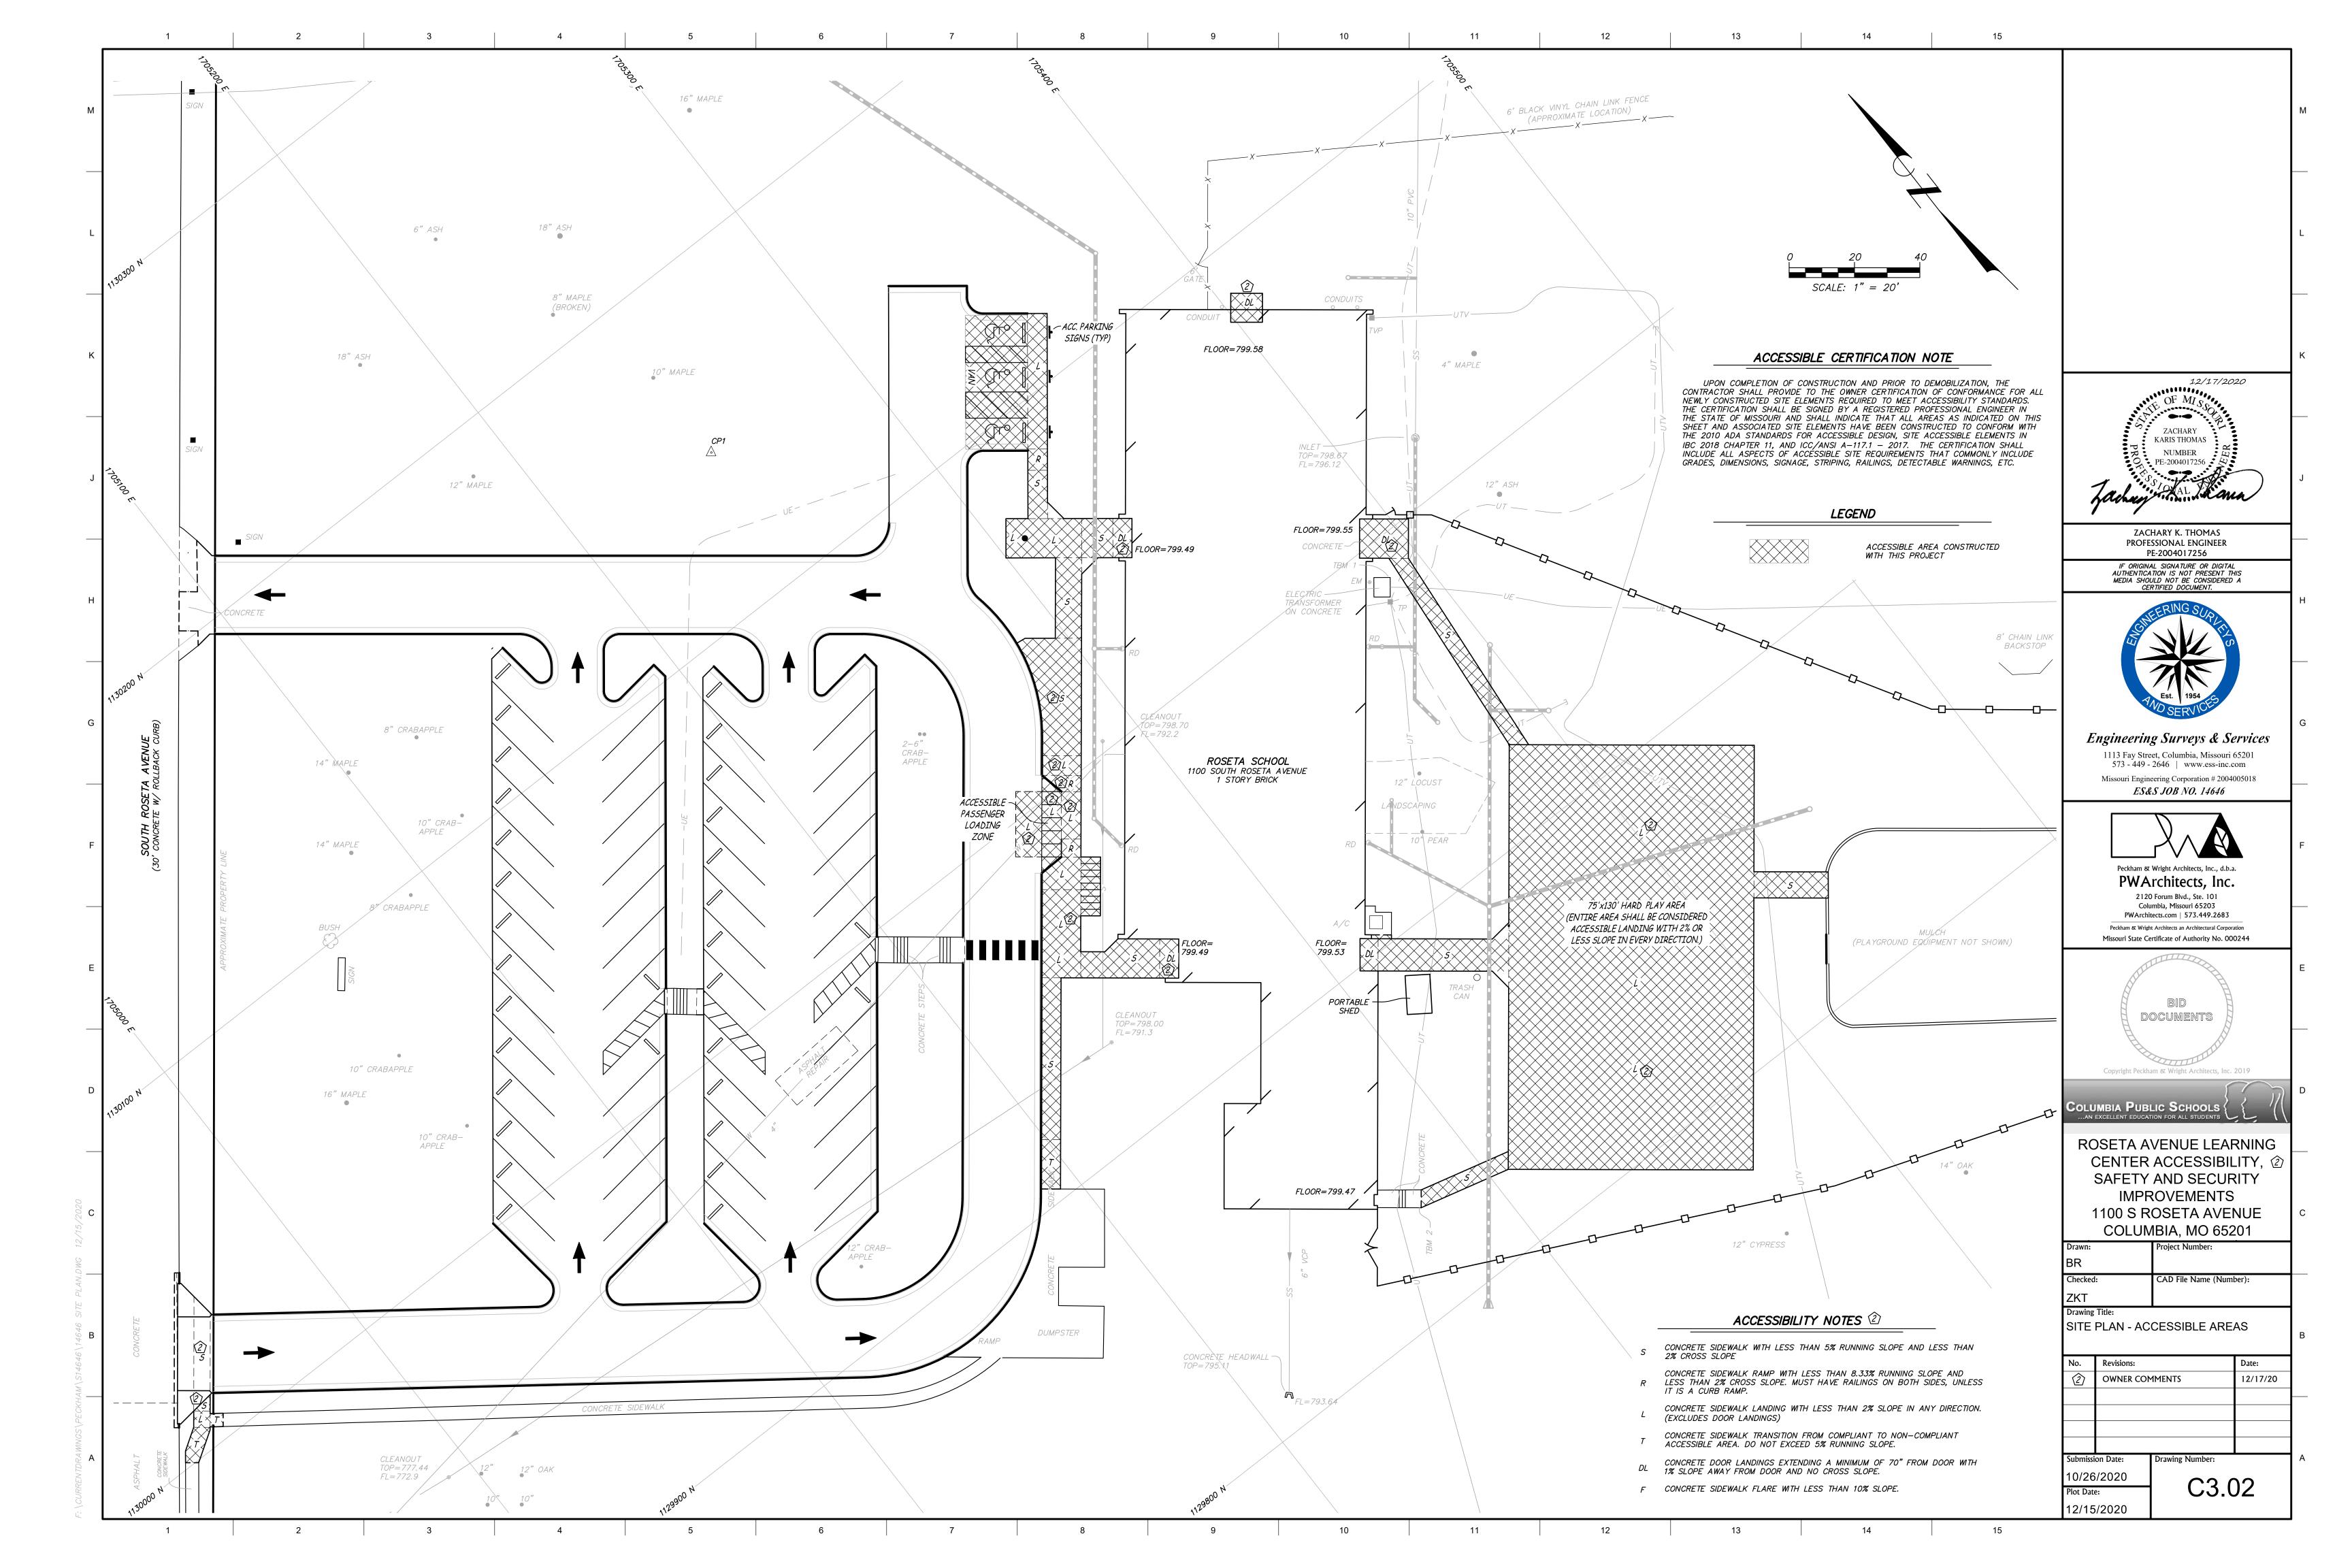
CONSTRUCTION NOTES GRADING AND STORM SEWER CONSTRUCTION NOTES STORM WATER POLLUTION PREVENTION PLAN NOTES 1. THE CONTRACTOR IS SPECIFICALLY CAUTIONED THAT THE LOCATION AND/OR ELEVATION OF EXISTING 1. CONTRACTOR SHALL FOLLOW THE STORM WATER POLLUTION PREVENTION PLAN (SWPPP) AND ADHERE TO 1. ALL STORM SEWER PIPES AND INLETS SHALL MEET HEAVY DUTY TRAFFIC (HS20) LOADING AND BE UTILITIES AS SHOWN ON THESE PLANS IS BASED ON RECORDS OF THE VARIOUS UTILITY COMPANIES, AND ALL TERMS & CONDITIONS AS OUTLINED IN THE GENERAL N.P.D.E.S. PERMIT FOR STORM WATER DISCHARGE WHERE POSSIBLE, MEASUREMENTS TAKEN IN THE FIELD. THE INFORMATION IS NOT TO BE RELIED ON AS ASSOCIATED WITH CONSTRUCTION ACTIVITIES. A COPY OF THIS PLAN, SWPPP, AND ALL PERMITS SHALL BEING EXACT OR COMPLETE. THE CONTRACTOR MUST CALL THE APPROPRIATE UTILITY COMPANIES AT REMAIN ON SITE THROUGHOUT CONSTRUCTION. 2. ALL HDPE PIPE SHALL BE ADS N-12 ST SOIL TIGHT, SMOOTH INTERIOR PIPE OR APPROVED EQUAL. LEAST 72 HOURS BEFORE ANY EXCAVATION TO REQUEST EXACT FIELD LOCATION OF UTILITIES. IT SHALL BE THE RESPONSIBILITY OF THE CONTRACTOR TO RELOCATE ALL EXISTING UTILITIES WHICH CONFLICT WITH THE INSTALLATION SHALL FOLLOW THE "EMBEDMENT OF PLASTIC STORM SEWER PIPE" DETAIL. 2. CONTRACTORS ARE REQUIRED TO SUBMIT TO BOONE COUNTY INSPECTION STAFF COPIES OF THEIR PROPOSED IMPROVEMENTS SHOWN ON THE PLANS. INSPECTION REPORTS REQUIRED BY THE SWPPP, IF REQUESTED. 12/17/2020 3. PVC PIPE MAY BE USED IN LIEU OF HDPE FOR DIAMETERS LESS THAN 15". PVC PIPE SHALL BE SDR 35 OR GREATER, AS REQUIRED BY DEPTH OR AS NOTED IN THESE PLANS. 2. CONSTRUCTION SHALL COMPLY WITH ALL APPLICABLE GOVERNING CODES AND BE CONSTRUCTED TO SAME. 3. NO LAND CLEARING OR GRADING SHALL BEGIN UNTIL ALL EROSION CONTROL MEASURES HAVE BEEN INSTALLED AND APPROVAL HAS BEEN RECEIVED FROM ALL GOVERNING AUTHORITIES. 3. IT SHALL BE THE RESPONSIBILITY OF THE CONTRACTOR TO PROTECT ALL IDENTIFIED PROPERTY CORNERS, 4. INLINE DRAIN AND DRAIN BASINS SHALL BE NYLOPLAST, HARCO, OR APPROVED EQUAL AND SHALL BE PVC CONFORMING TO ASTM D1784 CELL CLASS 12454. JOINTS SHALL BE WATER TIGHT FLEXIBLE ELASTOMERIC LAND SURVEY CORNERS, AND ACCESSORIES. THE CONTRACTOR SHALL CAUSE THE CORNERS AND 4. IMMEDIATELY UPON COMPLETION OF FINISH GRADING IN EACH AREA, ALL LANDSCAPING AREAS SHALL BE ACCESSORIES TO BE REFERENCED BY A LICENSED LAND SURVEYOR, AND ANY SUCH CORNER OR SEALS CONFORMING TO ASTM D3212. INLINE DRAIN AND DRAIN BASIN GRATES AND FRAMES SHALL BE ZACHARY SEEDED/SODDED PER PLANS, AND OR SPECIFICATIONS. ACCESSORIES DISTURBED OR DESTROYED DURING CONSTRUCTION SHALL BE RESET BY THE SURVEYOR AT DUCTILE IRON CONFORMING TO ASTM A536 GRADE 70-50-05, OR 80-55-06. KARIS THOMAS THE ORIGINAL LOCATION, AND FILE THE RESTORATIONS AND MONUMENT DOCUMENTS AS THE LAW REQUIRES. 5. CONTRACTOR SHALL ADJUST ALL GRATES, MANHOLES, VALVE BOXES, ETC. TO MATCH FINISH GRADES, AS 5. SHOULD CONSTRUCTION STOP FOR LONGER THAN 14 DAYS, THE SITE SHALL BE SEEDED AS SPECIFIED IN NUMBER 4. CONTRACTOR SHALL SUBMIT SHOP DRAWINGS TO ENGINEERING SURVEYS AND SERVICES FOR REVIEW AND REQUIRED. PE-2004017256 6. SITE INSPECTION SHOULD OCCUR ON A REGULAR SCHEDULE AND WITHIN 24 HOURS OF A STORM EVENT OF 6. ALL STRUCTURE CONNECTIONS SHALL BE WATERTIGHT. 0.25 INCHES OR GREATER. REGULARLY SCHEDULED INSPECTION SHALL BE A MINIMUM OF ONCE EVERY 7 5. ALL DIMENSIONS ARE TO BACK OF CURB, FACE OF SIDEWALK, OR EDGE OF PAVEMENT, UNLESS OTHERWISE 7. PIPE LENGTHS ARE GIVEN FROM CENTER OF STRUCTURE OR DOWNSTREAM END OF FLARED END SECTIONS. CALENDAR DAYS. ANY DEFICIENCIES SHALL BE NOTED IN A WEEKLY REPORT OF THE INSPECTION AND CORRECTED WITHIN SEVEN CALENDAR DAYS OF THE REPORT. 8. ALL FLARED END SECTIONS FOR PLASTIC PIPE SHALL BE GALVANIZED METAL, UNLESS OTHERWISE NOTED. 6. ALL WORK WITHIN RIGHT-OF-WAY SHALL BE CONSTRUCTED PER BOONE COUNTY SPECIFICATIONS. 7. THIS PLAN SHALL NOT BE CONSIDERED ALL INCLUSIVE AS THE CONTRACTOR SHALL TAKE ALL NECESSARY CONTRACTOR SHALL OBTAIN ALL PERMITS AND PAY ALL FEES FROM BOONE COUNTY TO WORK WITHIN 9. ALL EXCESS EARTHEN MATERIAL SHALL BE SPREAD AND COMPACTED ONSITE PER OWNER'S DIRECTION AND PRECAUTIONS TO PREVENT SOIL SEDIMENT FROM LEAVING THE SITE. ZACHARY K. THOMAS STABILIZED PER ALL LOCAL, STATE, AND FEDERAL REQUIREMENTS. PROFESSIONAL ENGINEER 8. CONTRACTOR SHALL COMPLY WITH ALL STATE AND LOCAL ORDINANCES THAT APPLY. (2) 7. ALL STRIPING SHALL BE A MINIMUM OF 2 COATS AND RETROREFLECTIVE. PE-2004017256 10. ALL SITES USED FOR IMPORTING OR EXPORTING OF FILL MATERIAL SHALL HAVE AN ACTIVE MISSOURI 9. ADDITIONAL EROSION AND SEDIMENT CONTROL MEASURES SHALL BE INSTALLED IF DEEMED NECESSARY BY DEPARTMENT OF NATURAL RESOURCES LAND DISTURBANCE PERMIT, AS REQUIRED. 8. CONTRACTOR SHALL ADJUST AND/OR CUT EXISTING PAVEMENT AS NECESSARY TO ASSURE A SMOOTH FIT AUTHENTICATION IS NOT PRESENT THIS ON SITE INSPECTION. MEDIA SHOULD NOT BE CONSIDERED A 11. CONTRACTOR SHALL REMOVE OFFSITE ALL TRASH AND DEBRIS, TREES AND BRUSH, AND OTHER MATERIAL 10. CONTRACTOR SHALL BE RESPONSIBLE TO TAKE WHATEVER MEANS NECESSARY TO ESTABLISH PERMANENT 9. ALL TRAFFIC CONTROL SHALL BE PER CURRENT MUTCD REQUIREMENTS AND SHALL BE THE RESPONSIBILITY CREATED AS A RESULT OF CONSTRUCTION. MATERIAL SHALL BE DISPOSED OF IN COMPLIANCE WITH ALL OF THE CONTRACTOR. A TRAFFIC CONTROL PLAN WILL BE REQUIRED FOR ANY WORK WITHIN THE RIGHT-OF-WAY AND SHALL BE APPROVED AND PERMITTED BY THE CITY OF COLUMBIA PRIOR TO APPLICABLE LAWS AND REGULATIONS. BURNING ON SITE SHALL NOT BE ALLOWED. 11. CONTRACTOR SHALL REMOVE ALL TRASH, DEBRIS, TREES & BRUSH AND OTHER MATERIAL CREATED AS A 12. CONTRACTOR SHALL REMOVE ALL STUMPS BY EXCAVATING TO INCLUDE REMOVAL OF ASSOCIATED ROOT RESULT OF THE CONSTRUCTION WORK AND THE SITE SHALL BE RETURNED TO ITS ORIGINAL CONDITION. 10. IF A CONFLICT EXISTS BETWEEN THE CIVIL PLANS AND CIVIL SPECIFICATIONS, THE CIVIL PLANS SHALL 12. ALL PERIMETER LANDSCAPED AREAS SHALL BE GRASS COVERED. 13. CONTRACTOR SHALL NOT ADVANCE TRENCH EXCAVATION BEYOND AMOUNT THAT CAN ACCOMMODATE PIPE INSTALLATION AND BACKFILLING AT THE END OF EACH DAY. 13. IN ORDER TO TERMINATE A MISSOURI DEPARTMENT OF NATURAL RESOURCES (MDNR) STATE OPERATING 11. ALL BIKE RACKS SHALL BE HUNTCO RAMBLER MODEL BR9, 2" STEEL PIPE, 36" HEIGHT, FLANGE MOUNT, PERMIT, THE CONTRACTOR SHALL SUBMIT A REQUEST FOR TERMINATION OF OPERATING PERMIT FORM TO 14. ENGINEERED FILL SHOULD BE FREE OF FROZEN SOIL, ORGANICS, RUBBISH, LARGE ROCKS, WOOD, OR OTHER WITH HOT DIPPED GALVANIZED FINISH, OR APPROVED EQUAL. MDNR. A PERMIT IS ELIGIBLE FOR TERMINATION WHEN EITHER PERENNIAL VEGETATION, PAVEMENT, DELETERIOUS MATERIAL. COHESIVE FILLS SHOULD BE UNIFORMLY COMPACTED TO AT LEAST 95 PERCENT OF BUILDINGS, OR STRUCTURES USING PERMANENT MATERIALS COVER ALL AREAS THAT HAVE BEEN THE "STANDARD" MAXIMUM DRY DENSITY AND BE WITHIN THE MOISTURE CONTENTS AS DESCRIBED IN THE 12. CONTRACTOR SHALL BE REQUIRED TO OBTAIN ALL REQUIRED PERMITS AND PAY ALL FEES. DISTURBED. VEGETATIVE COVER SHOULD BE AT LEAST 70% OF FULLY ESTABLISHED PLANT DENSITY OVER PROJECT GEOTECHNICAL REPORT. GRANULAR FILLS SHOULD BE UNIFORMLY COMPACTED TO AT LEAST 95 PERCENT OF THE "STANDARD" MAXIMUM DRY DENSITY. THE MOISTURE CONTENT SHOULD BE HIGH ENOUGH 13. CONTRACTOR SHALL PROVIDE ALL CONSTRUCTION STAKING. TO PROVIDE FOR PROPER COMPACTION BUT LOW ENOUGH TO PREVENT UNDUE PUMPING. PLACE FILL 14. THE SITE CONTRACTOR SHALL INCLUDE MAINTENANCE OF ALL BMP'S AS PART OF THEIR CONTRACT AND 14. CONTRACTOR SHALL BE RESPONSIBLE FOR MAINTAINING SITE ACCESS AT ALL TIMES. THIS INCLUDES MATERIAL IN LOOSE LIFTS NOT TO EXCEED 8 INCHES IN THICKNESS. SHALL BE RESPONSIBLE FOR THE PROJECT UNTIL THE NPDES PERMIT IS TERMINATED. TEMPORARY ACCESS TO THE BACK OF THE BUILDING. ALL TEMPORARY ACCESS IMPROVEMENTS SHALL BE Engineering Surveys & Services REMOVED AND DISTURBED AREAS SHALL BE RESTORED TO PRE PROJECT CONDITIONS. 15. ROCKS AND STONES THAT EXCEED THE THICKNESS OF THE LOOSE LIFT FILL LAYER SHOULD BE REMOVED AND DISPOSED OF OFF THE IMMEDIATE CONSTRUCTION AREA. 1113 Fay Street, Columbia, Missouri 65201 15. EROSION CONTROL BLANKETS OR MATS SHALL NOT BE INSTALLED WITHOUT OWNERS PRIOR APPROVAL. 573 - 449 - 2646 | www.ess-inc.com 16. IMPORTED SOILS PROPOSED FOR USE AS FILL OR BACKFILL SHOULD BE REVIEWED AND ANALYZED BY THE GEOTECHNICAL ENGINEER PRIOR TO USE ON SITE. SOIL CLASSIFIED AS MH, OH, OL, OR PT (HIGH Missouri Engineering Corporation # 2004005018 PLASTICITY SOILS AND ORGANIC SOILS) BY THE UNIFIED SOIL CLASSIFICATION SYSTEM (ASTM D2487) ES&S JOB NO. 14646 SHOULD NOT BE IMPORTED FOR USE ÁS ENGINEERED FILL. SUITABLE IMPORTED MATERÌALS FOR GENERAI UTILITY CONSTRUCTION NOTES SITE FILL ARE THOSE THAT CLASSIFY AS GW, GM, GC, SC, AND CL IN ACCORDANCE WITH ASTM D 2487 SEQUENCE OF EVENTS MATERIALS CLASSIFIED AS CH SHOULD BE APPROVED BY THE GEOTECHNICAL ENGINEER PRIOR TO THEIR IMPORTATION AND ONLY USED OUTSIDE THE BUILDING PAD AT DEPTHS BELOW THE UPPER 2 FEET OF LOCATION OF SITE UTILITIES SHALL BE VERIFIED BY CONTRACTOR AND THE PROPER UTILITY COMPANY SUBGRADE. SUBJECT TO FINAL DESIGN REQUIREMENTS FOR WALL BACKFILL, SUITABLE IMPORTED MATERIALS PROVIDING SERVICE PRIOR TO THE START OF CONSTRUCTION. FOR WALL AND TRENCH BACKFILL ARE THOSE THAT CLASSIFY AS GW, GP, GM, GC, SM, SW, SP, SC, AND 1. PRIOR TO CONSTRUCTION, COORDINATE AND HAVE A PRE-CONSTRUCTION MEETING REGARDING SWPPP CL IN ACCORDANCE WITH ASTM D2487. TRAINING WITH ANYONE INVOLVED IN LAND DISTURBANCE ACTIVITIES. 2. EXISTING UTILITIES SHALL BE VERIFIED IN FIELD PRIOR TO INSTALLATION OF ANY NEW LINES. 17. FILLS PLACED IN AREAS WHERE THE NATURAL SLOPE IS GREATER THAN 5H:1V (HORIZONTAL TO VERTICAL) Peckham & Wright Architects, Inc., d.b.a. 2. CONTRACTOR SHALL FIELD VERIFY ALL BENCHMARKS AND SURVEY CONTROL POINTS PRIOR TO 3. UTILITY TIE-INS ARE SHOWN IN APPROXIMATE LOCATIONS. REFER TO MEP PLANS FOR EXACT TIE-IN OF SHOULD BE BENCHED INTO THE EXISTING GRADE TO REDUCE THE POTENTIAL FOR SLIPPAGE BETWEEN CONSTRUCTION. CONTACT ENGINEERING SURVEYS & SERVICES REPRESENTATIVES IMMEDIATELY WITH ANY PWArchitects, Inc. EXISTING SLOPES AND ENGINEERED FILL. BENCHES SHOULD BE LEVEL AND WIDE ENOUGH TO NOTED DISCREPANCIES. ACCOMMODATE COMPACTION AND EARTH MOVING EQUIPMENT. 2120 Forum Blvd., Ste. 101 4. SITE CONTRACTOR SHALL COORDINATE WITH ALL UTILITY COMPANIES FOR INSTALLATION REQUIREMENTS AND 3. CONTRACTOR SHALL DETERMINE ALL UTILITY FIELD LOCATES AS NECESSARY. Columbia, Missouri 65203 SPECIFICATIONS. 18. FILL AND SUBGRADE CONSTRUCTION SHOULD NOT BE STARTED ON FOUNDATION SOIL, PARTIALLY PWArchitects.com | 573.449.2683 COMPLETED FILL, OR SUBGRADES THAT CONTAIN FROST OR ICE. FILL SHOULD NOT BE CONSTRUCTED 4. INSTALL INITIAL PERIMETER EROSION AND SEDIMENT CONTROL PER PLAN. 5. ALL TRENCHING, PIPE LAYING, AND BACKFILLING SHALL BE IN ACCORDANCE WITH FEDERAL OSHA Peckham & Wright Architects an Architectural Corporation USING FROZEN SOIL. FROZEN SOIL SHOULD BE REMOVED PRIOR TO PLACING FILL MATERIAL REGULATIONS. BACKFILL OF ALL TRENCHES SHALL BE COMPACTED TO MINIMUM 95% STANDARD PROCTOR 5. INSTALL SITE LIGHTING PER MEP PLANS. COORDINATE SO SITE HAS OPERABLE SITE LIGHTING AT ALL TIMES. Missouri State Certificate of Authority No. 000244 DENSITY (ASTM D-698). 19. AFTER STRIPPING AND GRUBBING OPERATIONS ARE COMPLETED AND PRIOR TO FILL PLACEMENT, AREAS TO BE FILLED SHALL BE PROOF ROLLED USING A LOADED TANDEM AXLE DUMP TRUCK TO IDENTIFY SOFT AND 6. STRIP TOPSOIL AND STOCKPILE WHERE INDICATED. IMMEDIATELY PLACE SEDIMENT CONTROL AROUND 6. ALL UNDERGROUND LINES SHALL BE INSTALLED, INSPECTED AND APPROVED BEFORE BACKFILLING. UNSUITABLE AREAS. SOFT MATERIAL MAY BE MOISTURE CONDITIONED AND REUSED AS ENGINEERED FILL, STOCKPILE PER PLAN. UNSUITABLE AND DELETERIOUS MATERIAL SHALL BE REMOVED FROM SITE. 7. TOPS OF EXISTING HANDHOLES SHALL BE RAISED AS NECESSARY TO BE FLUSH WITH PROPOSED FINISHED 7. COMMENCE SITE DEMOLITION PER PLAN. 20. ALL NEW TRENCHES SHOULD BE BACKFILLED AND COMPACTED IN ACCORDANCE WITH APPROPRIATE 8. DISTURBED AREAS OF THE SITE WHERE CONSTRUCTION ACTIVITY HAS CEASED FOR MORE THAN 14 DAYS CONTROLLED ENGINEERED FILL SPECIFICATIONS. 8. ALL NECESSARY INSPECTIONS AND/OR CERTIFICATIONS REQUIRED BY CODE AND/OR UTILITY SERVICE SHALL BE TEMPORARILY SEEDED, MULCHED, AND WATERED, EXCEPT AS PRECLUDED BY SNOW COVER. IN COMPANIES SHALL BE PERFORMED PRIOR TO THE FINAL CONNECTION OF SERVICE. 21. FIELD DENSITY TESTS SHOULD BE CONDUCTED IN ACCORDANCE WITH ASTM D6938 (NUCLEAR METHODS) OR DOCUMENTS THE EVENT OF SNOW COVER, STABILIZATION MEASURES MUST BE INITIATED AS SOON AS PRACTICAL THEREAFTER. DISTURBED AREAS OF THE SITE WHERE CONSTRUCTION ACTIVITY WILL CEASE FOR 12 MONTHS ASTM D 1556 (SAND CONE METHOD). FIELD DENSITY TESTS SHOULD BE PERFORMED AT THE RATE OF ONE 9. REFER TO MEP PLANS FOR SITE LIGHTING, WATER, AND TELECOMMUNICATION PLANS. OR MORE SHALL BE PERMANENTLY SEEDED AND MULCHED. TEST PER 2,500 SQUARE FEET PER LIFT BENEATH PAVEMENTS. SIDEWALKS, AND OTHER POTENTIAL STRUCTURAL AREAS WITH A MINIMUM OF 3 TESTS PER LIFT AND ONE TEST PER 100 LINEAL FEET PER LIFT 10. A MINIMUM 18" OF VERTICAL SEPARATION SHALL BE MAINTAINED BETWEEN THE OUTSIDE OF THE ELECTRIC 9. MAINTAIN ALL WEATHER ACCESS TO SITE AREAS AS REQUIRED BY OWNER THROUGHOUT THE PROJECT. FOR FOUNDATION, TRENCH AND WALL BACKFILL. CONDUIT AND THE OUTSIDE OF THE WATER, STORM SEWER, SANITARY SEWER, OR GAS PIPE AT ALL 10. COMMENCE BUILDING AND STORM SEWER CONSTRUCTION. INSTALL STORM SEWER INLET PROTECTION 22. PARKING AREAS AND ASPHALT PLAY AREA SHALL BE PROOF-ROLLED WITH A FULLY LOADED TANDEM Copyright Peckham & Wright Architects, Inc. 2019 AXLE DUMP TRUCK TO IDENTIFY ANY SOFT OR UNSUITABLE AREAS, PRIOR TO BASE ROCK PLACEMENT. THE IMMEDIATELY UPON COMPLETION OF EACH STRUCTURE. INSTALL OTHER CONTROL DEVICES AS 11. THE SITE CONTRACTOR IS RESPONSIBLE TO IDENTIFY AND CONSTRUCT ALL UTILITY CROSSINGS SO GRAVITY PROOF-ROLL SHALL BE OBSERVED BY A GEOTECHNICAL ENGINEER. AREAS IDENTIFIED AS UNSUITABLE CONSTRUCTION ALLOWS. DRAINED SEWERS CAN BE CONSTRUCTED TO THE GRADES INDICATED ON THESE PLANS. SHALL BE REMEDIED AS DIRECTED BY THE GEOTECHNICAL ENGINEER AND OWNER. 11. FINALIZE PAVEMENT SUBGRADE PREPARATION IN ACCORDANCE WITH PLANS AND PROJECT SPECIFICATIONS. Columbia Public Schools (23. CONTRACTOR SHALL ASSURE POSITIVE DRAINAGE AWAY FROM ALL BUILDINGS FOR ALL LANDSCAPED AND 12. INSTALL BASE MATERIAL AS REQUIRED FOR PAVED AREAS. PAVED AREAS. 13. COMMENCE PAVEMENT CONSTRUCTION. REMOVE INLET PROTECTION AROUND INLETS NO MORE THAN 48 24. CONTRACTOR SHALL PLACE STOCKPILED TOPSOIL FROM SITE IN ALL LANDSCAPE AREAS TO A MINIMUM ROSETA AVENUE LEARNING HOURS PRIOR TO PLACING STABILIZED BASE COURSE. DEPTH OF OF 6", UNLESS NOTED OTHERWISE IN PROJECT SPECIFICATIONS. HAZARDOUS SUBSTANCE NOTE CENTER ACCESSIBILITY, ② 14. COMPLETE ALL FINAL GRADING, TOPSOIL PLACEMENT, AND HYDROSEEDING OF ALL DISTURBED AREAS. 25. THE HAUL OFF OR HAUL ON OF ALL MATERIALS AS NECESSARY TO COMPLETE THE PROJECT AS SHOWN IN THESE PLANS SHALL BE BY THE CONTRACTOR AND INCLUDED IN THE BASE BID. SAFETY AND SECURITY 15. INSTALL SITE LANDSCAPING PER PLAN. 1. SUBSTANCES REGULATED BY FEDERAL LAW UNDER THE RESOURCE CONSERVATION AND RECOVERY ACT 26. ALL CONTOURS AND SPOT ELEVATIONS ARE TO FINISH GRADE. **IMPROVEMENTS** (RCRA) OR THE COMPREHENSIVE ENVIRONMENTAL RESPONSE COMPENSATION AND LIABILITY ACT (CERCLA) 16. REMOVE ALL REMAINING TEMPORARY EROSION AND SEDIMENT CONTROL DEVICES WHEN DISTURBED AREAS WHICH ARE TRANSPORTED, STORED OR USED FOR MAINTENANCE, CLEANING OR REPAIRS SHALL BE ARE STABILIZED. FINISH GRADE AND RESEED THESE AREAS AS NECESSARY. 1100 S ROSETA AVENUE MANAGED ACCORDING TO THE PROVISIONS OF RCRA AND CERCLA. COLUMBIA, MO 65201 2. ALL PAINTS, SOLVENTS, PETROLEUM PRODUCTS AND PETROLEUM WASTE PRODUCTS (EXCEPT FUELS) AND STORAGE CONTAINERS (SUCH AS DRUMS, CANS OR CARTONS) SHALL BE STORED SUCH THAT THESE roject Number: MATERIALS ARE NOT EXPOSED TO STORM WATER. SUFFICIENT PRACTICES OF SPILL PREVENTION, CONTROL AND/OR MANAGEMENT SHALL BE PROVIDED TO PREVENT ANY SPILLS OF THESE POLLUTANTS FROM 201621.51 ENTÉRING A WATER OF THE STATE. ANY CONTAINMENT SYSTEM USED TO IMPLEMENT THIS REQUIREMENT CAD File Name (Number): SHALL BE CONSTRUCTED OF MATERIALS COMPATIBLE WITH THE SUBSTANCES CONTAINED AND SHALL ALSO PREVENT THE CONTAMINATION OF GROUNDWATER. 3. THE APPLICANT SHALL NOTIFY BY TELEPHONE AND IN WRITING THE DEPARTMENT OF NATURAL RESOURCES, Drawing Title: WATER POLLUTION CONTROL PROGRAM, POST OFFICE BOX 176, JEFFERSON CITY, MO 65102, 1-800-361-4827, OF ANY OIL SPILLS OR IF HAZARDOUS SUBSTANCES ARE FOUND DURING THE GENERAL NOTES PROSECUTION OF WORK UNDER THIS PERMIT. Revisions: Date: **OWNER COMMENTS** 12/17/20 rawing Number ıbmission Date: 6/25/2020 12/15/2020










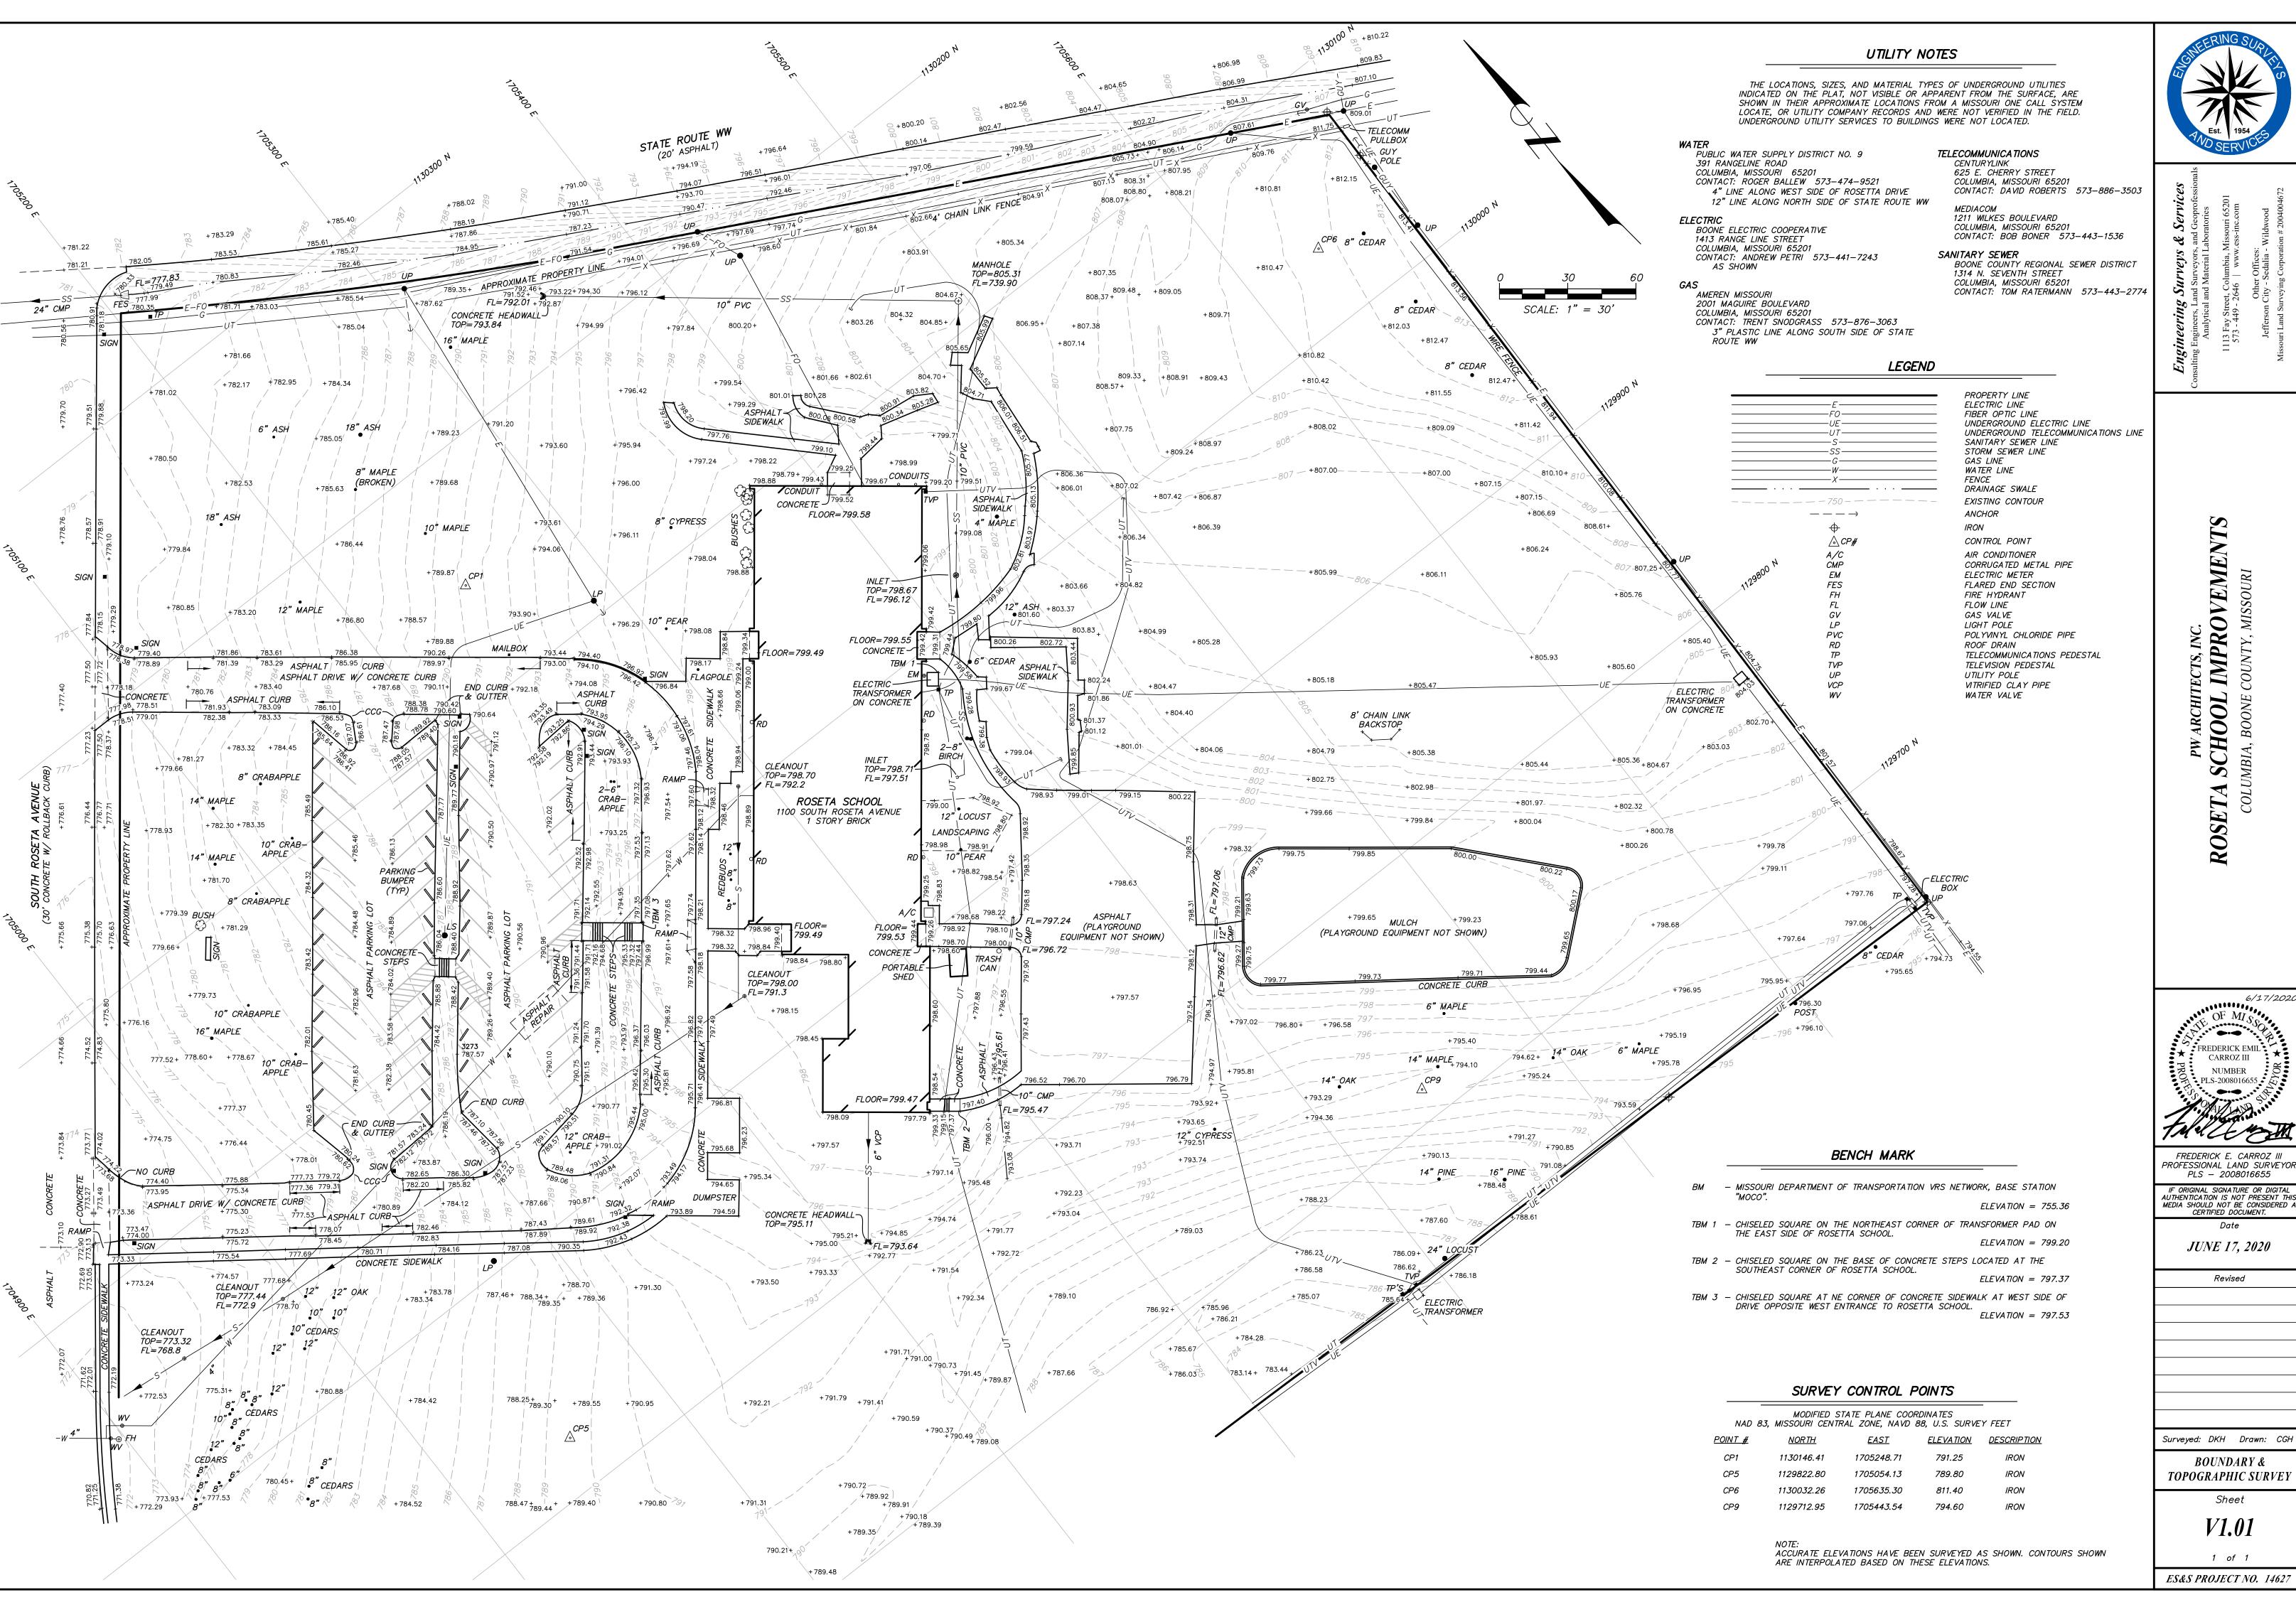


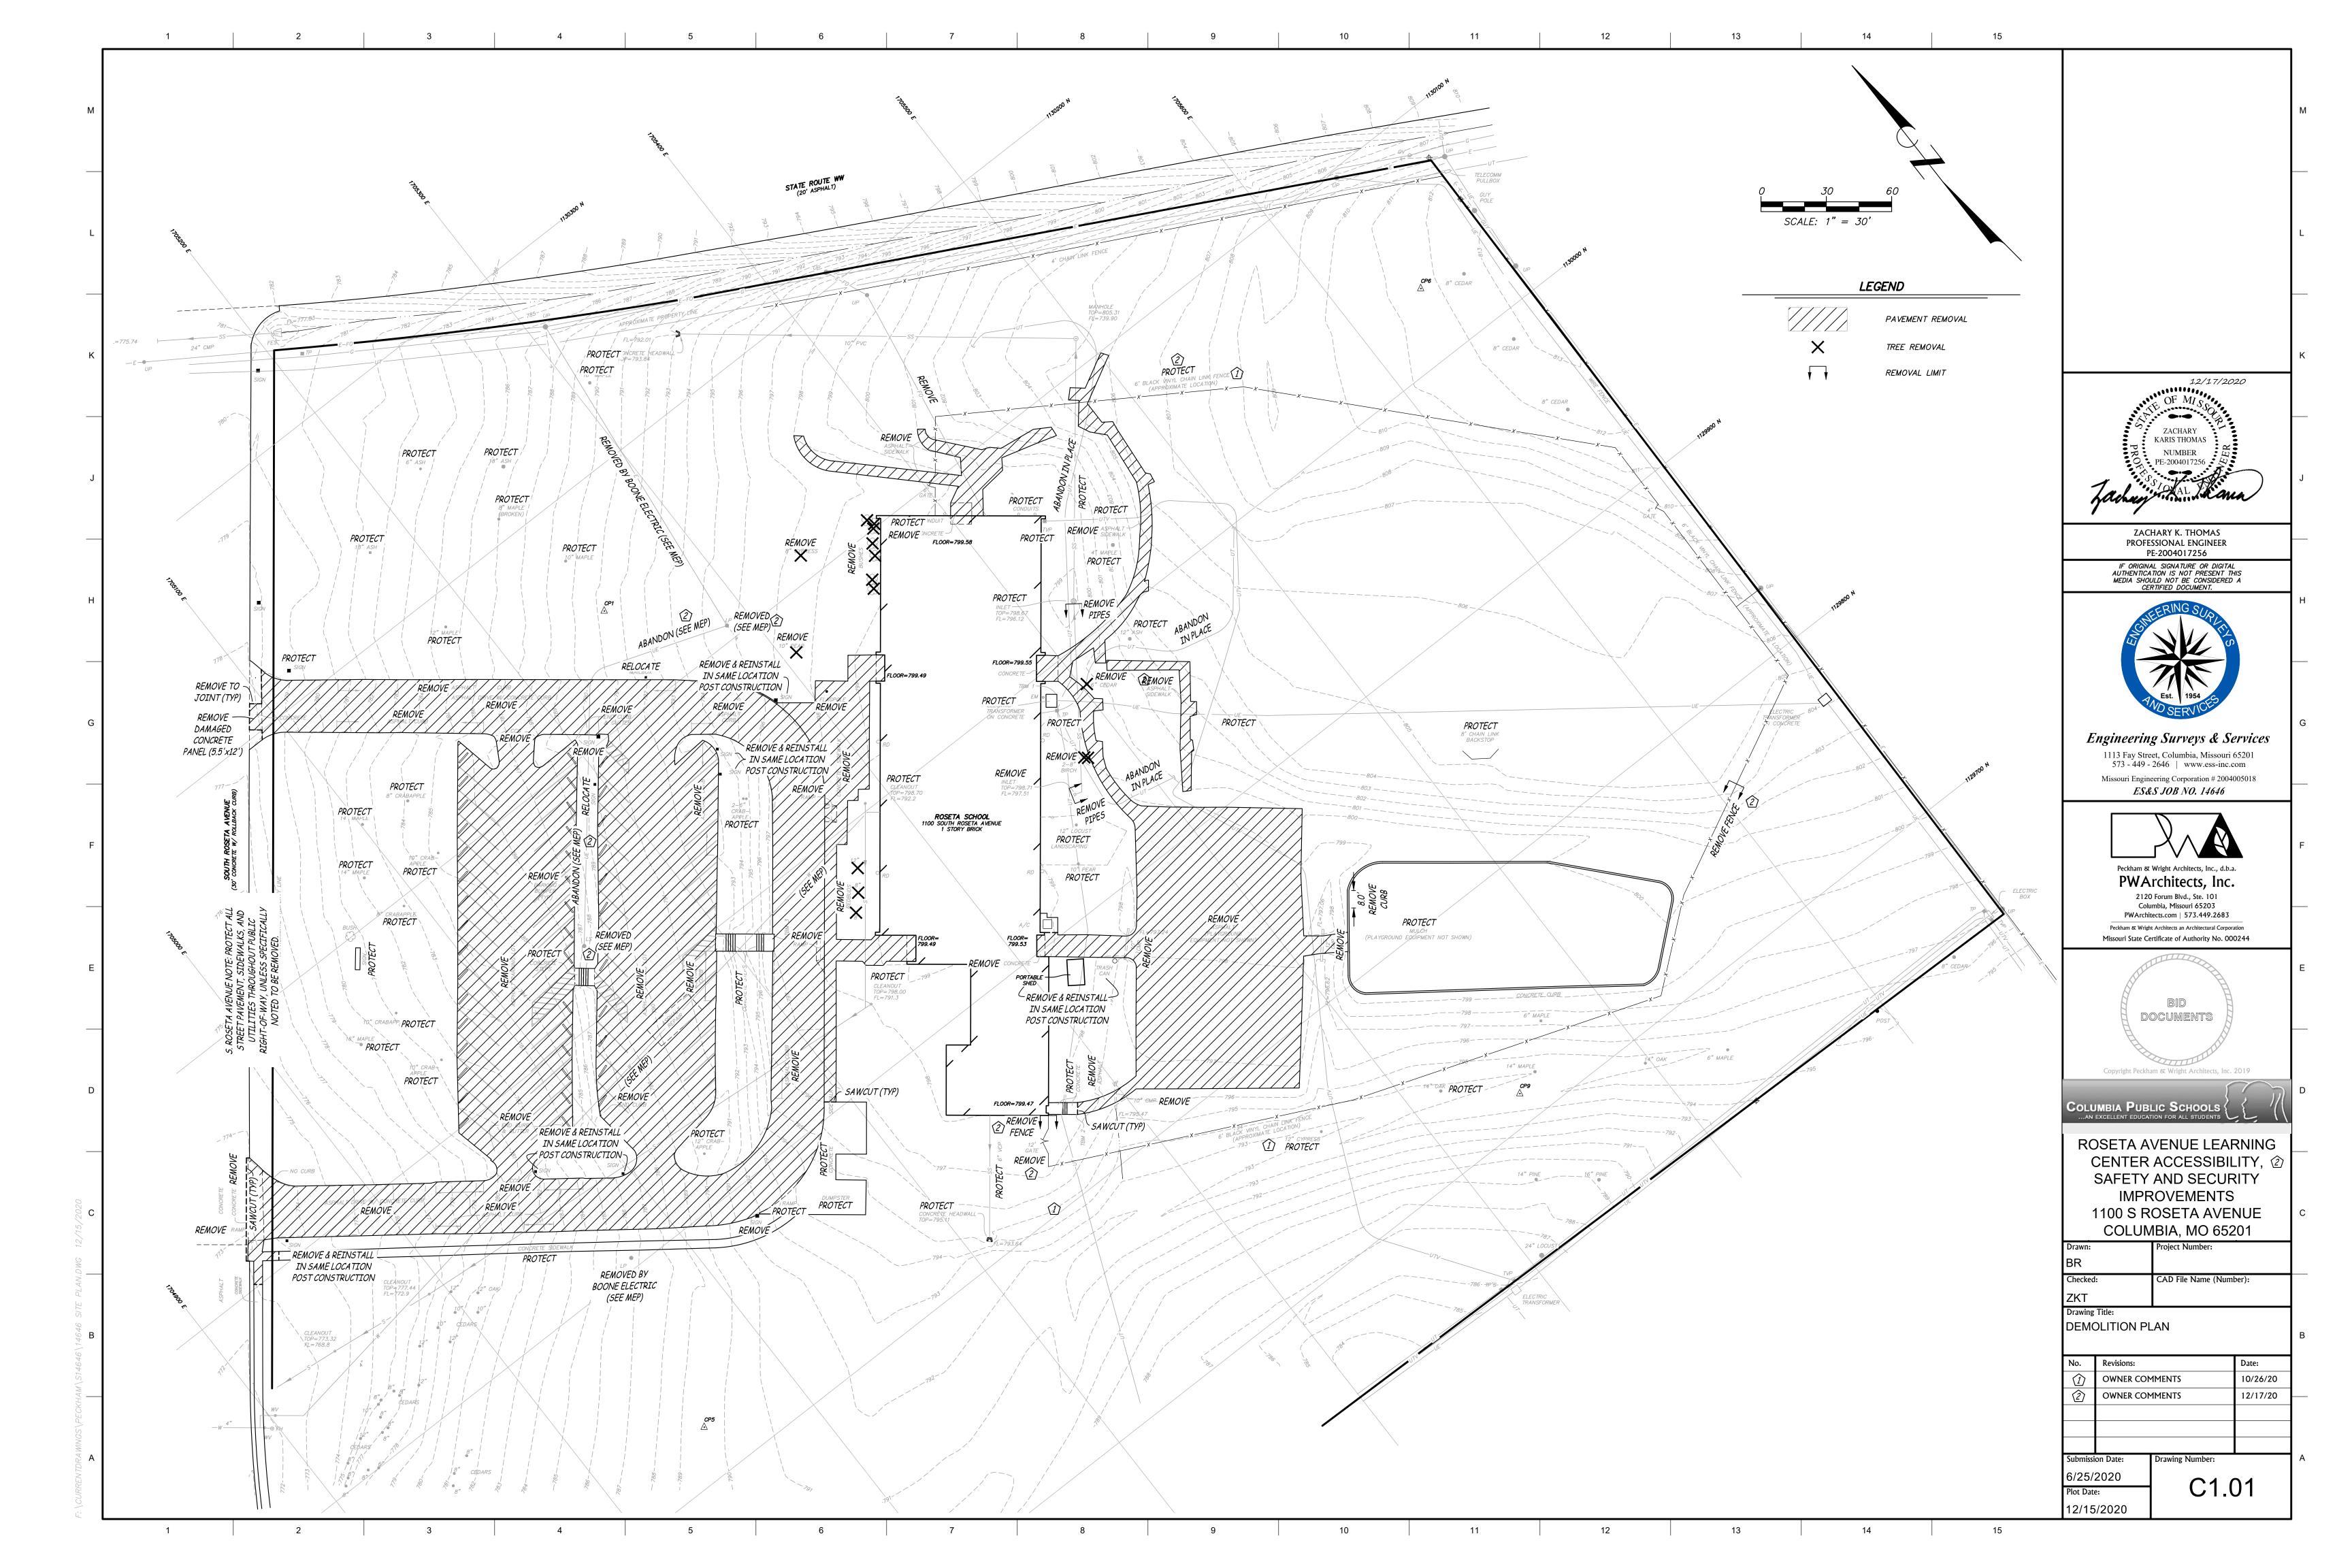


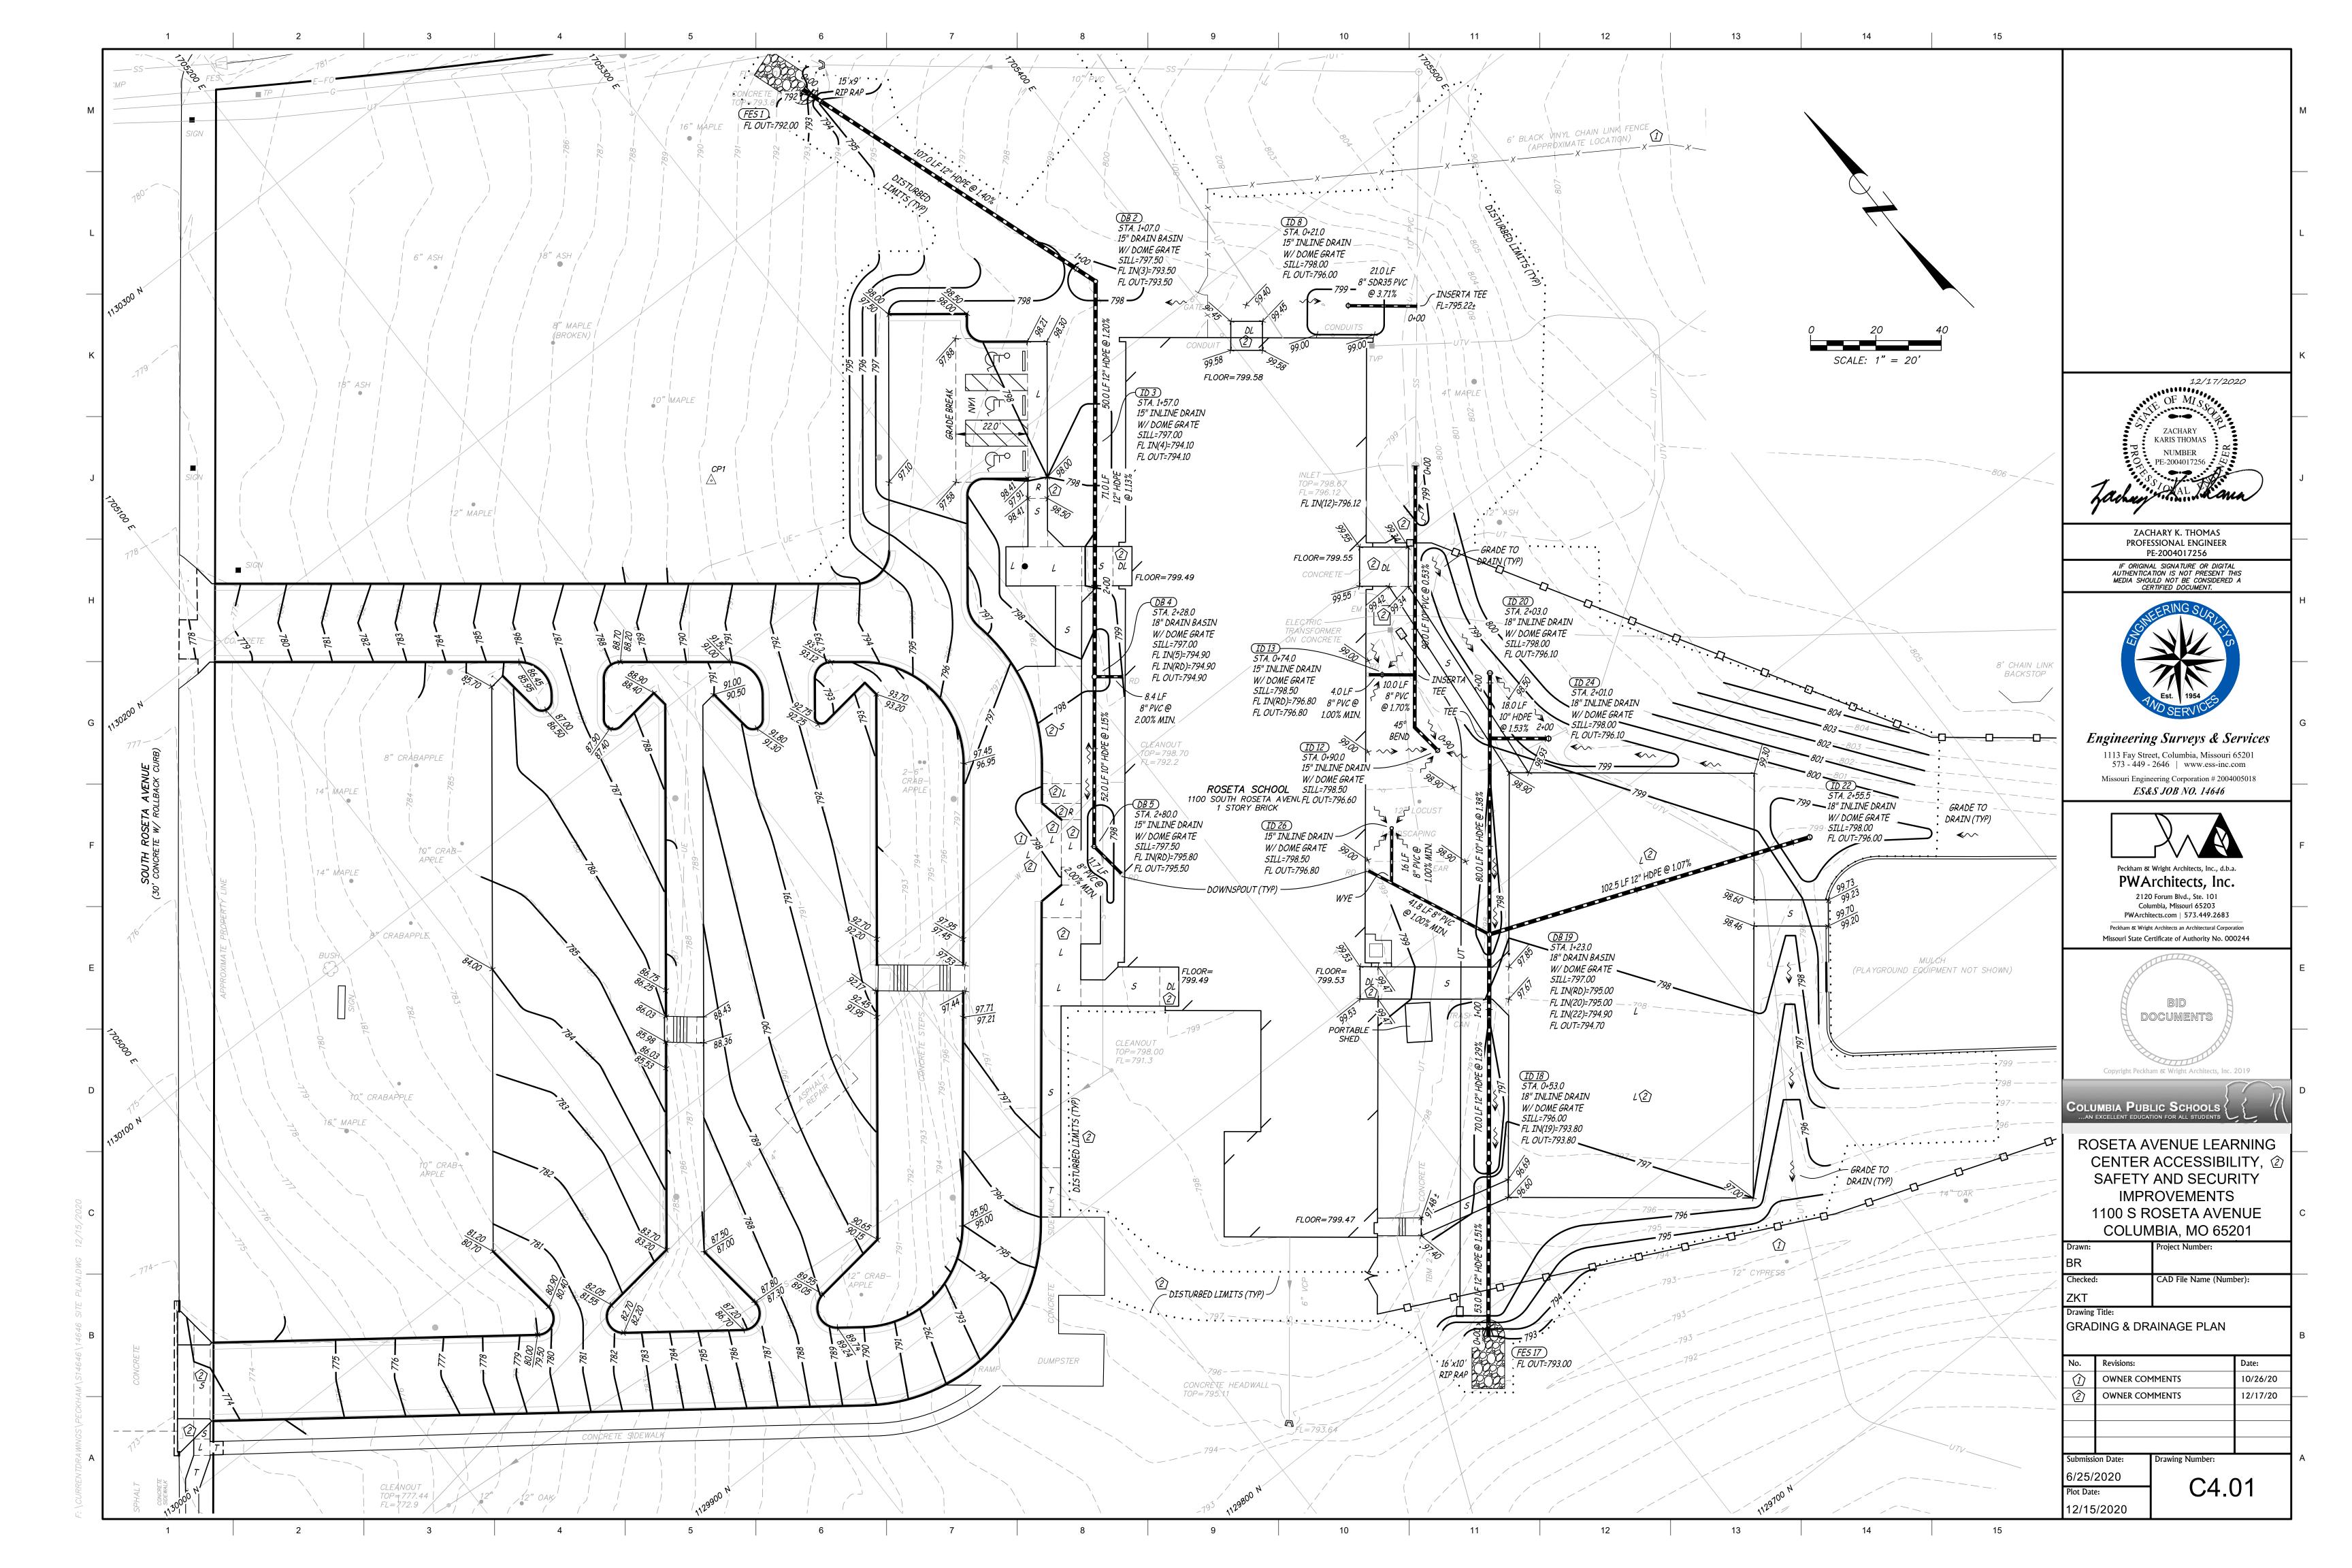


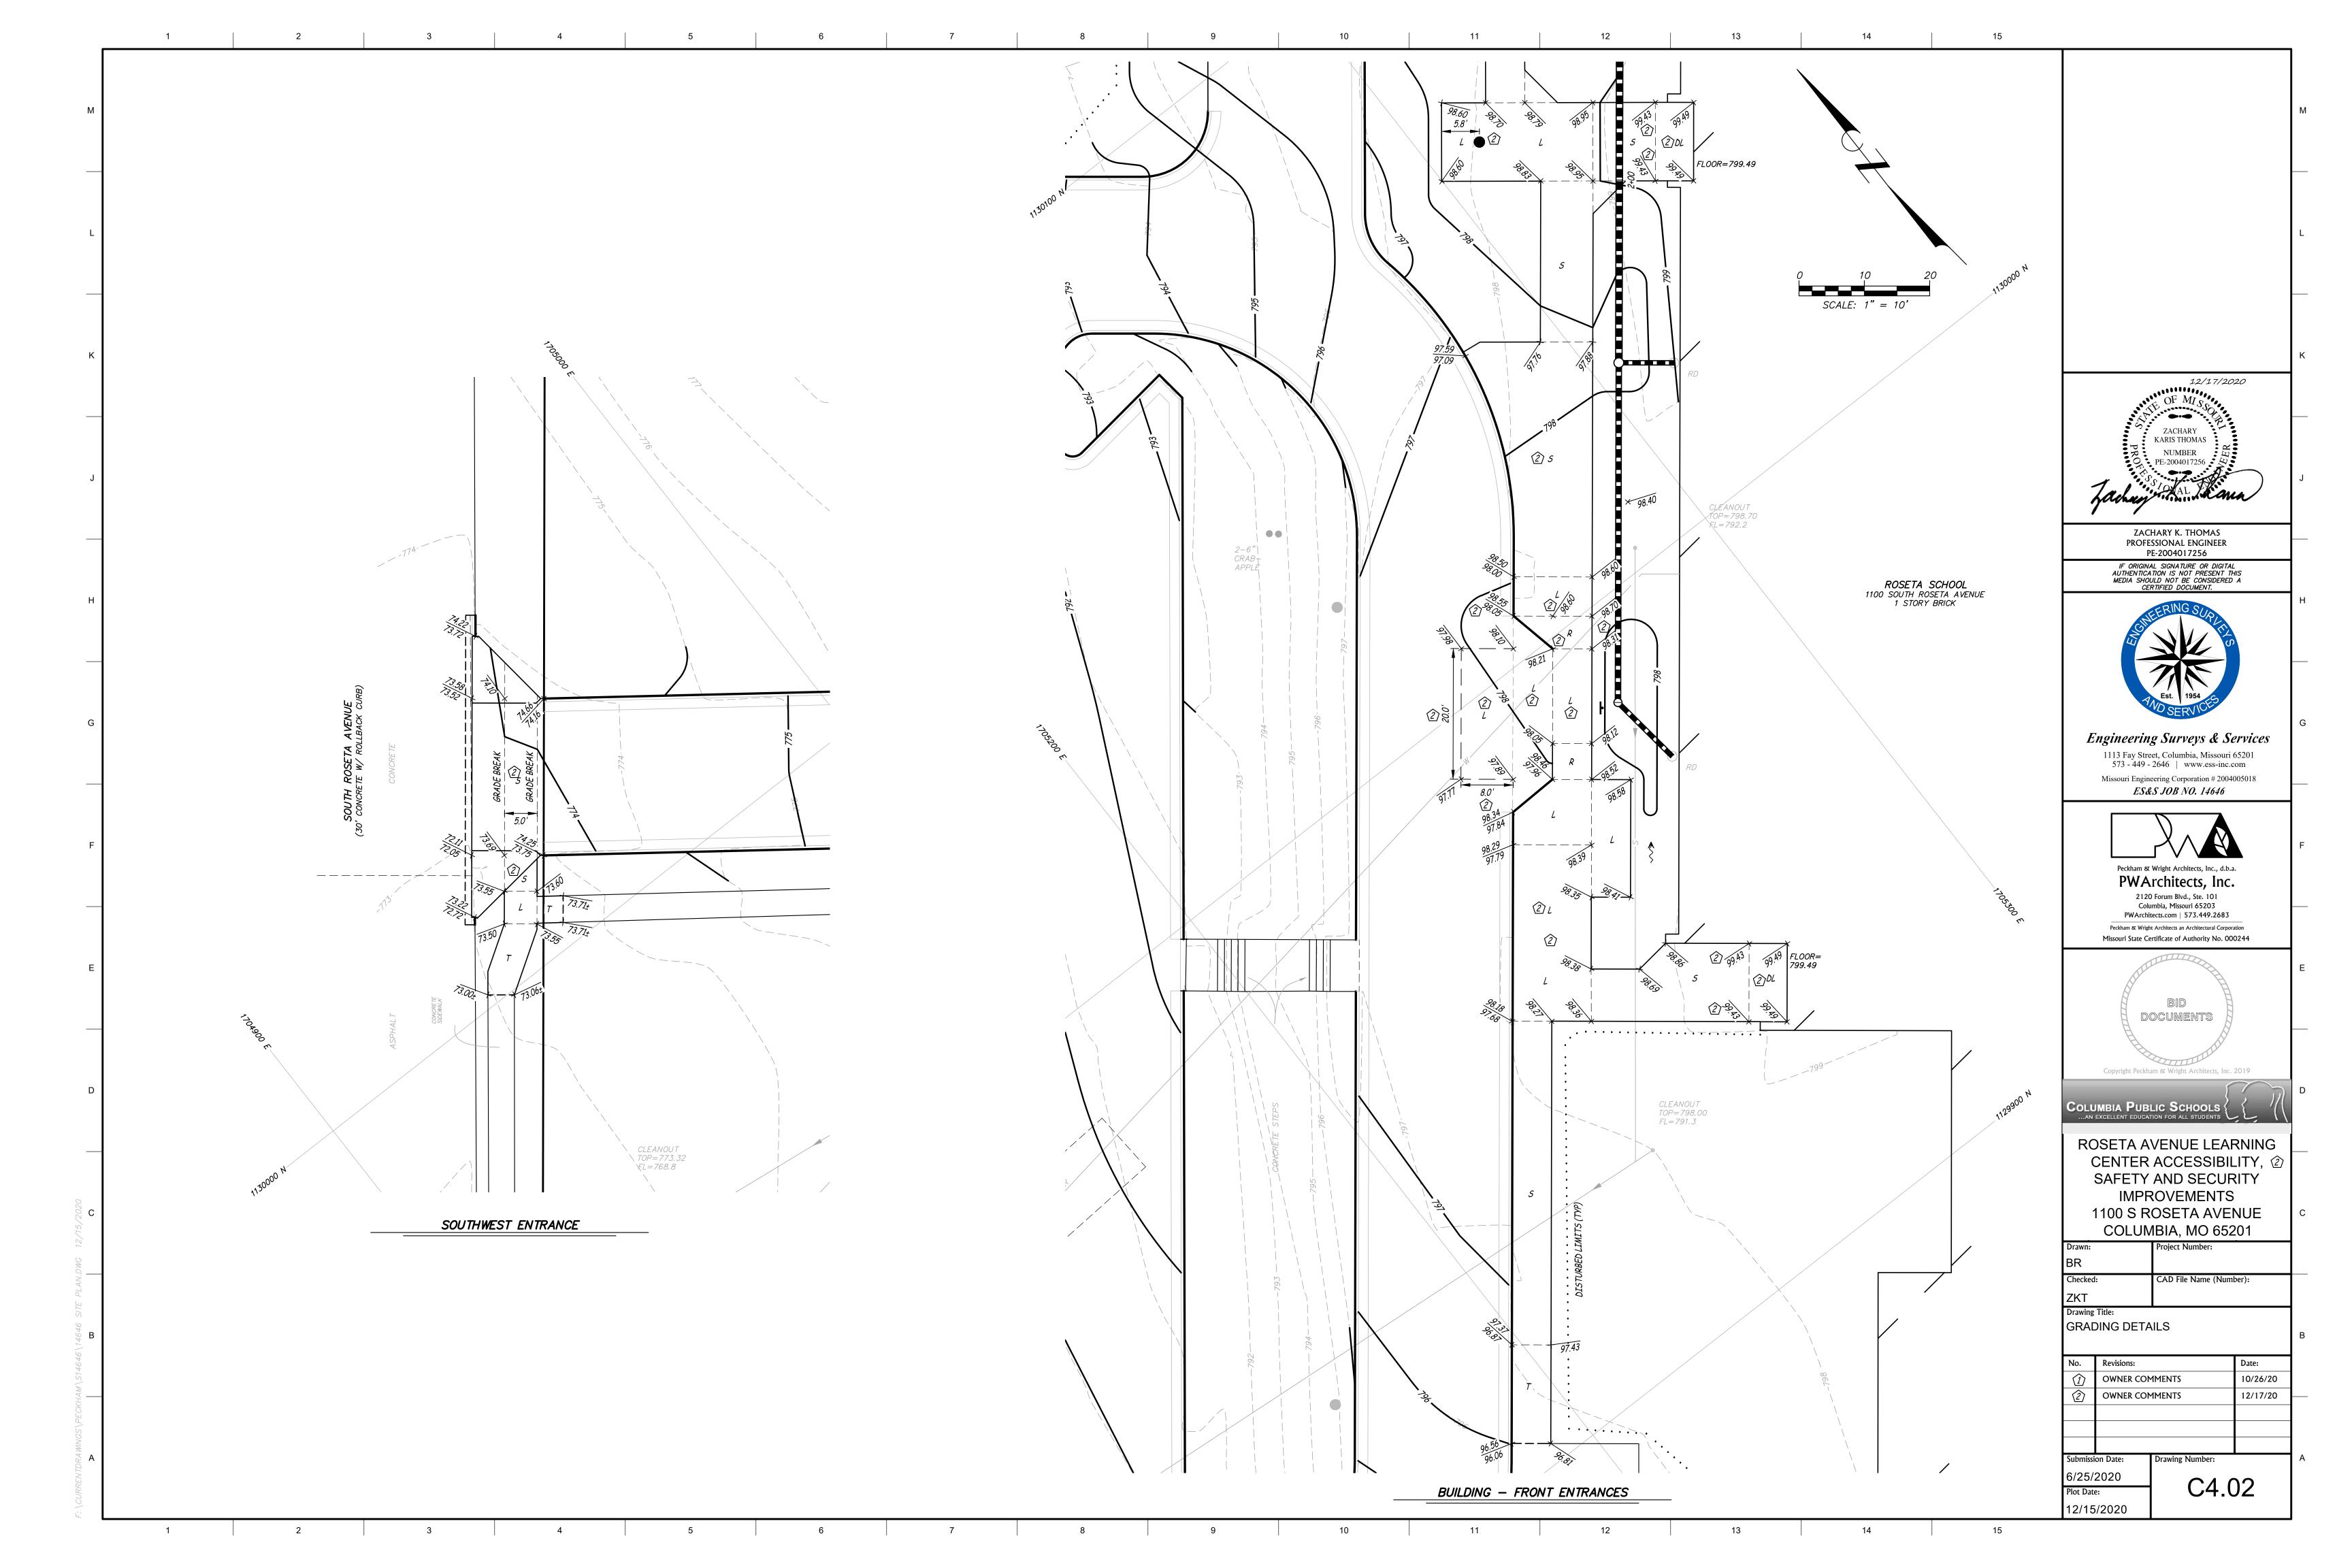


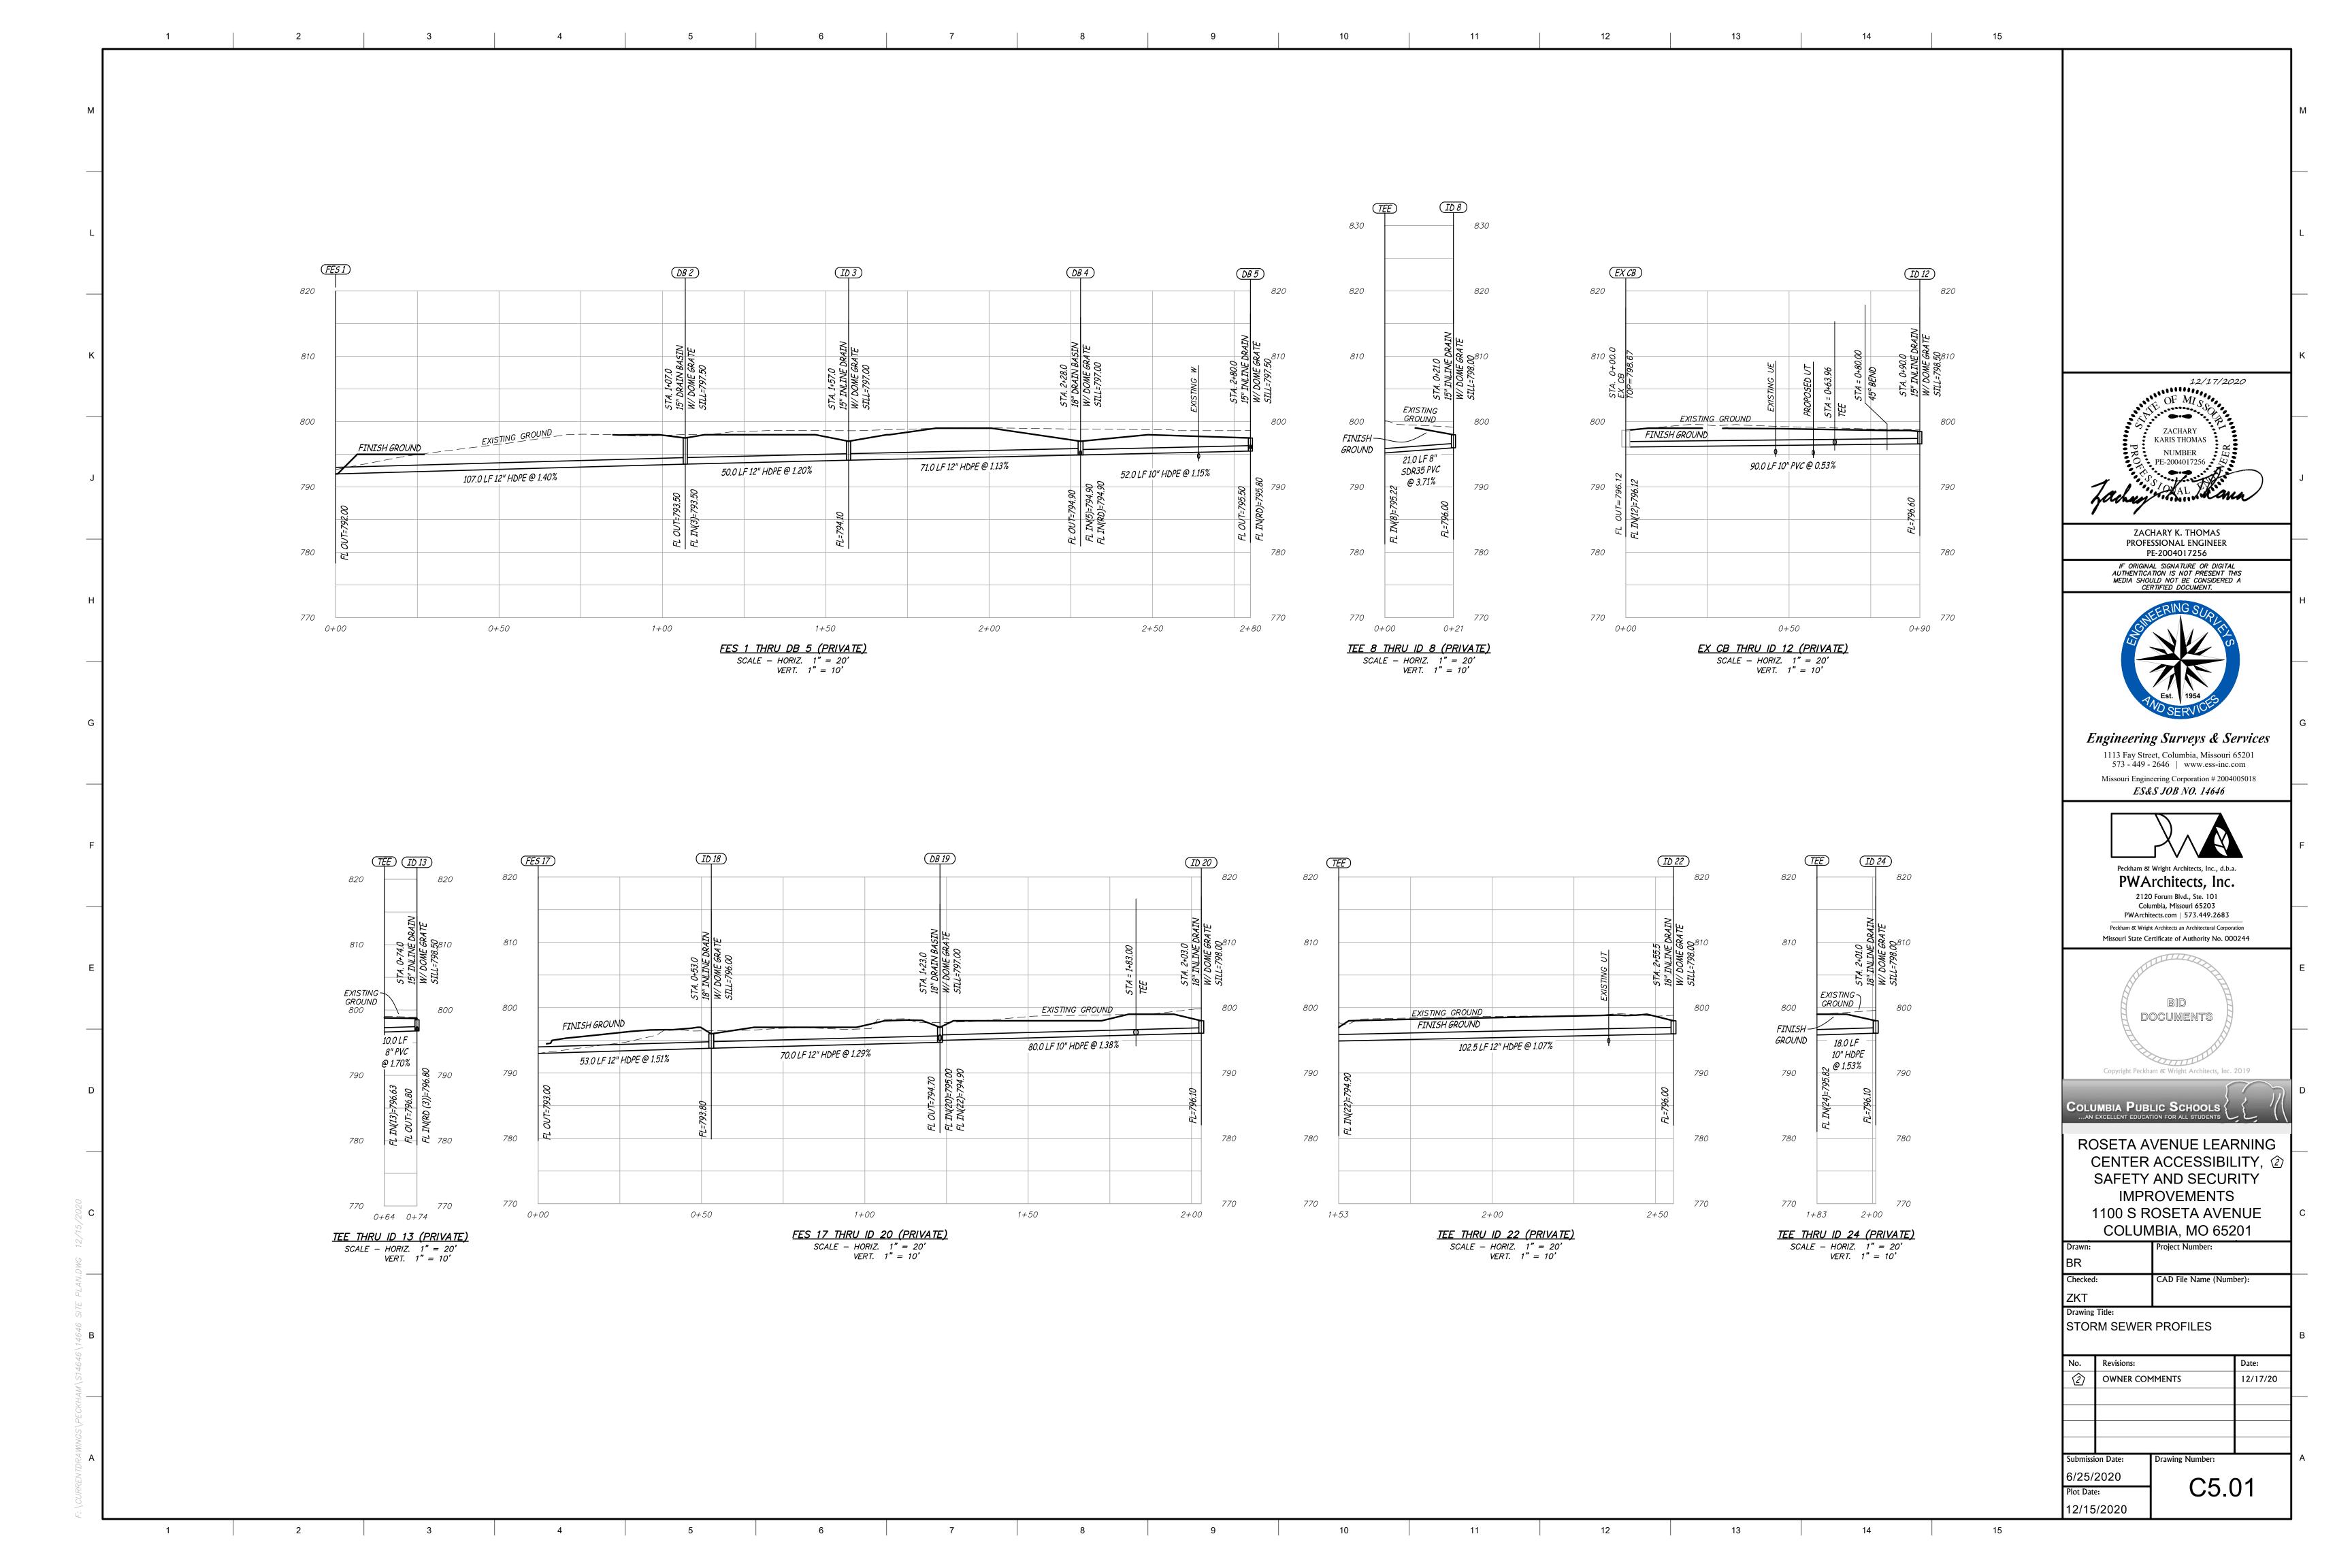


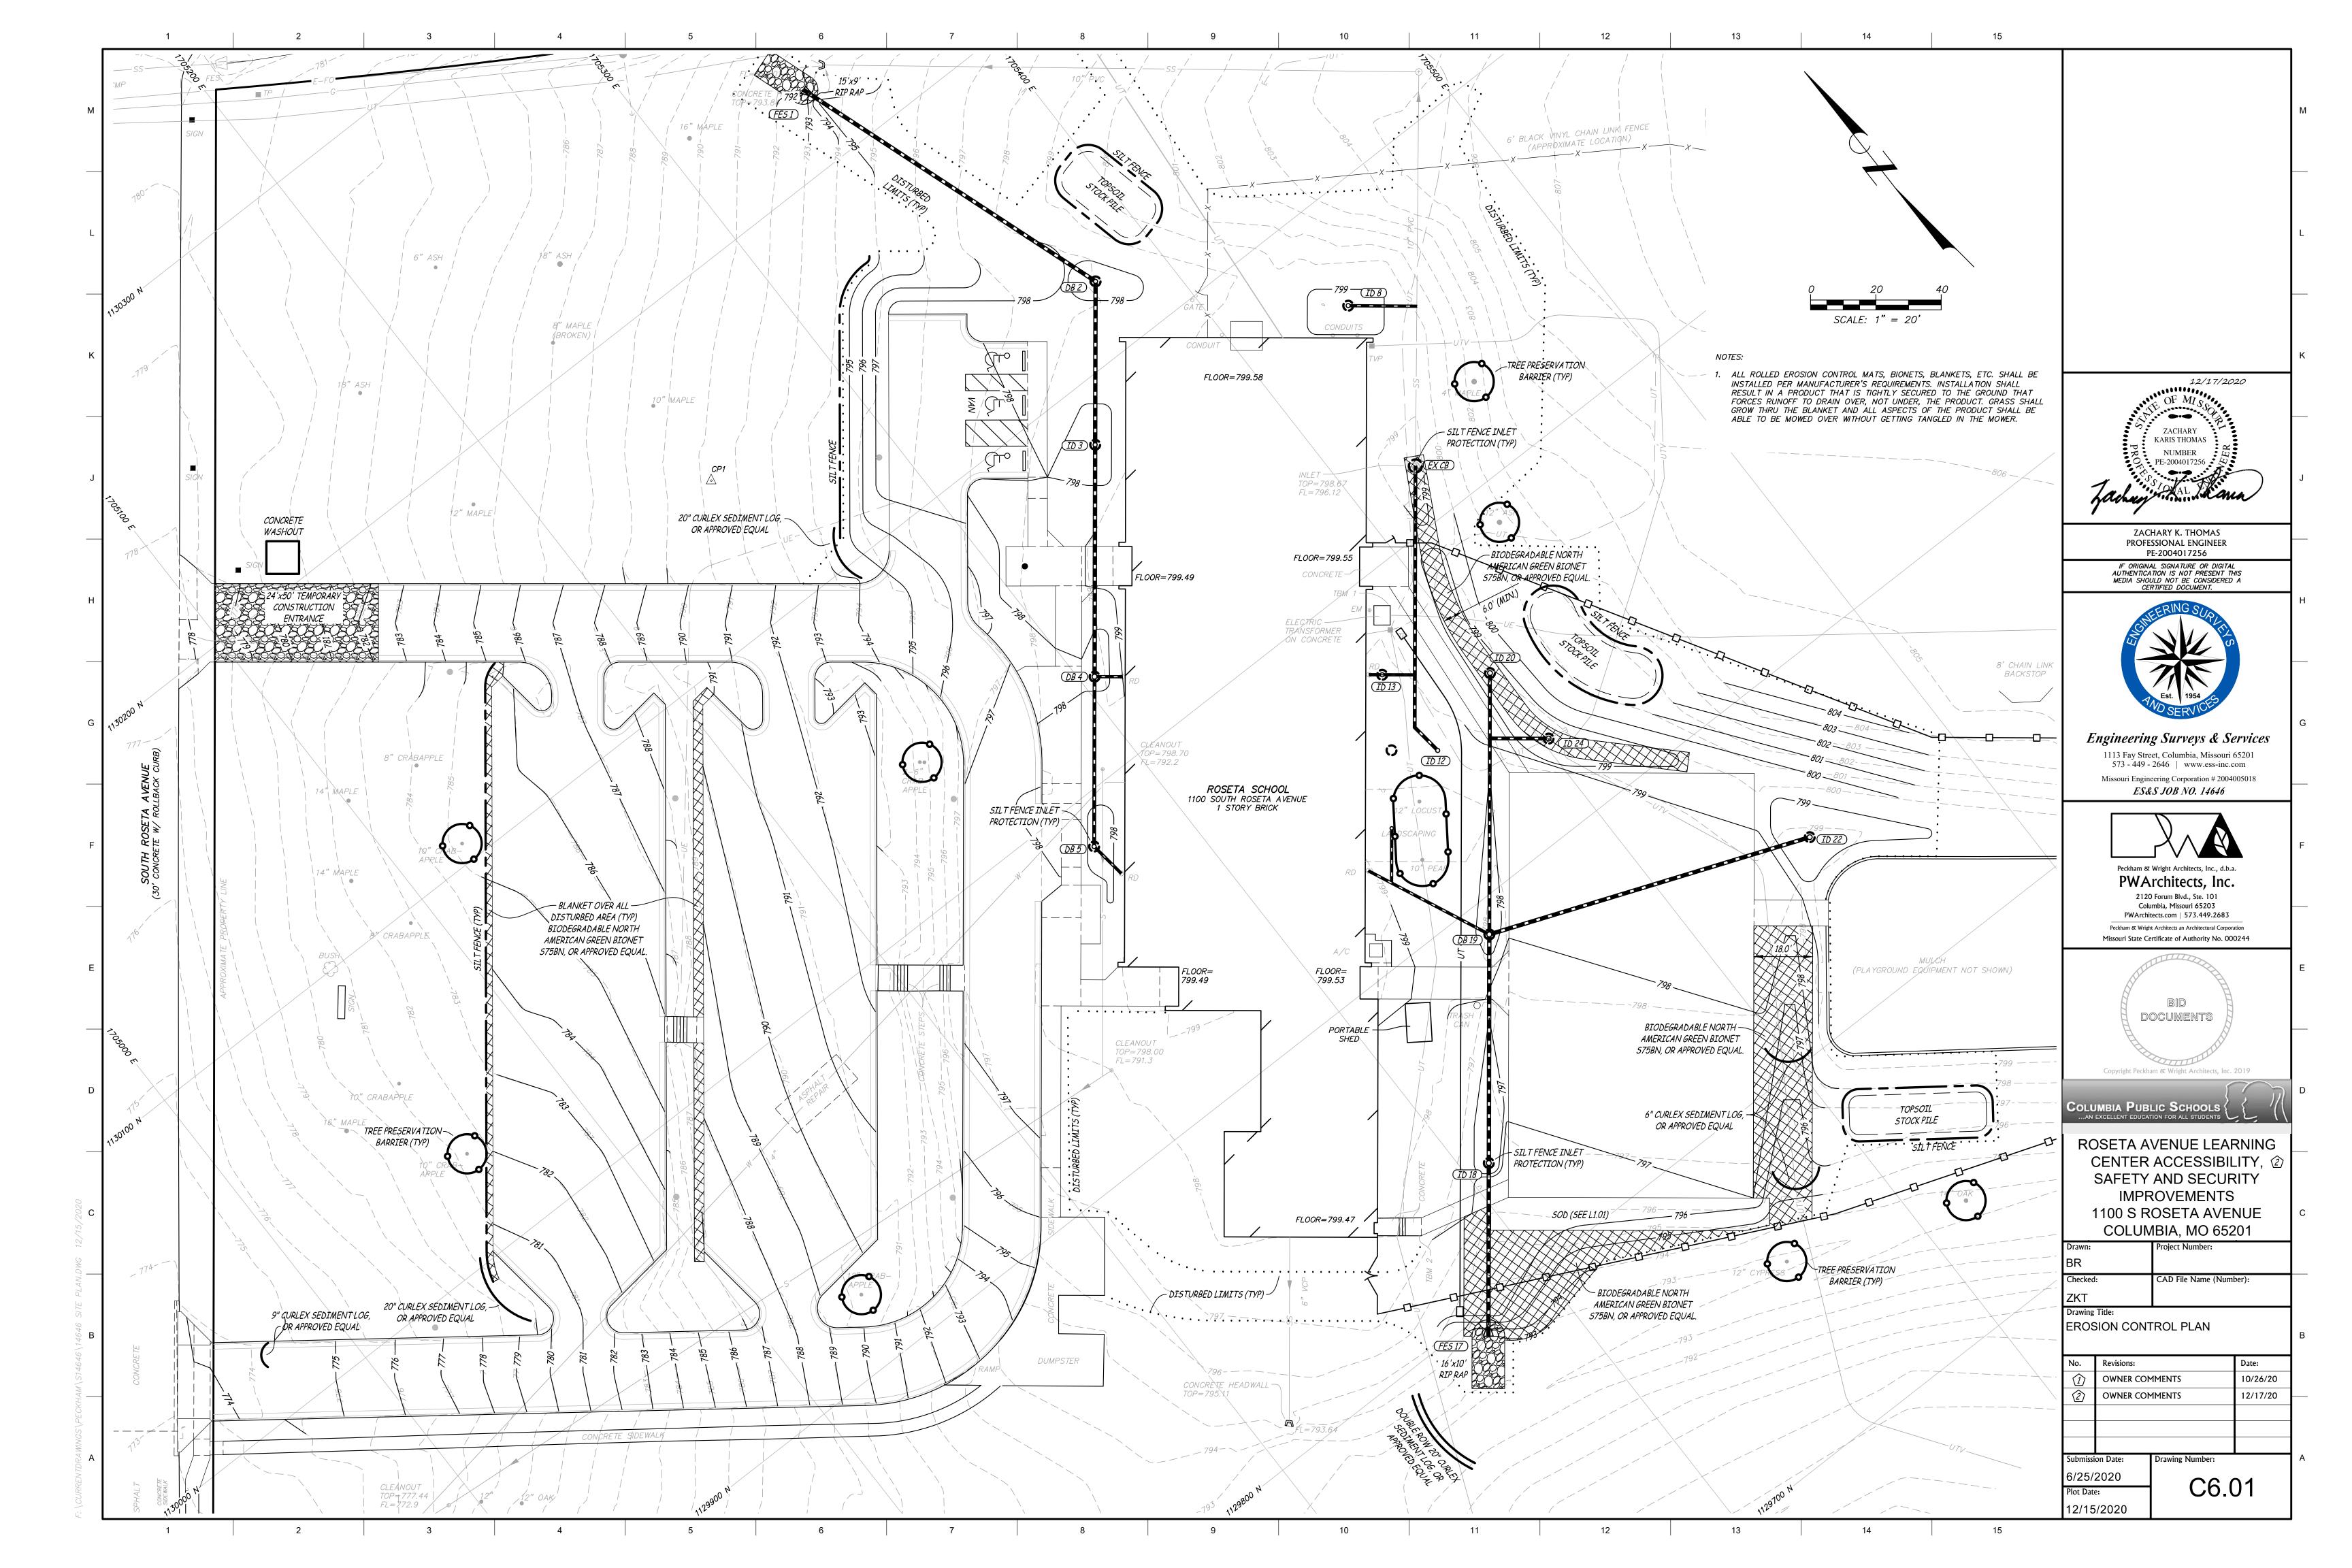


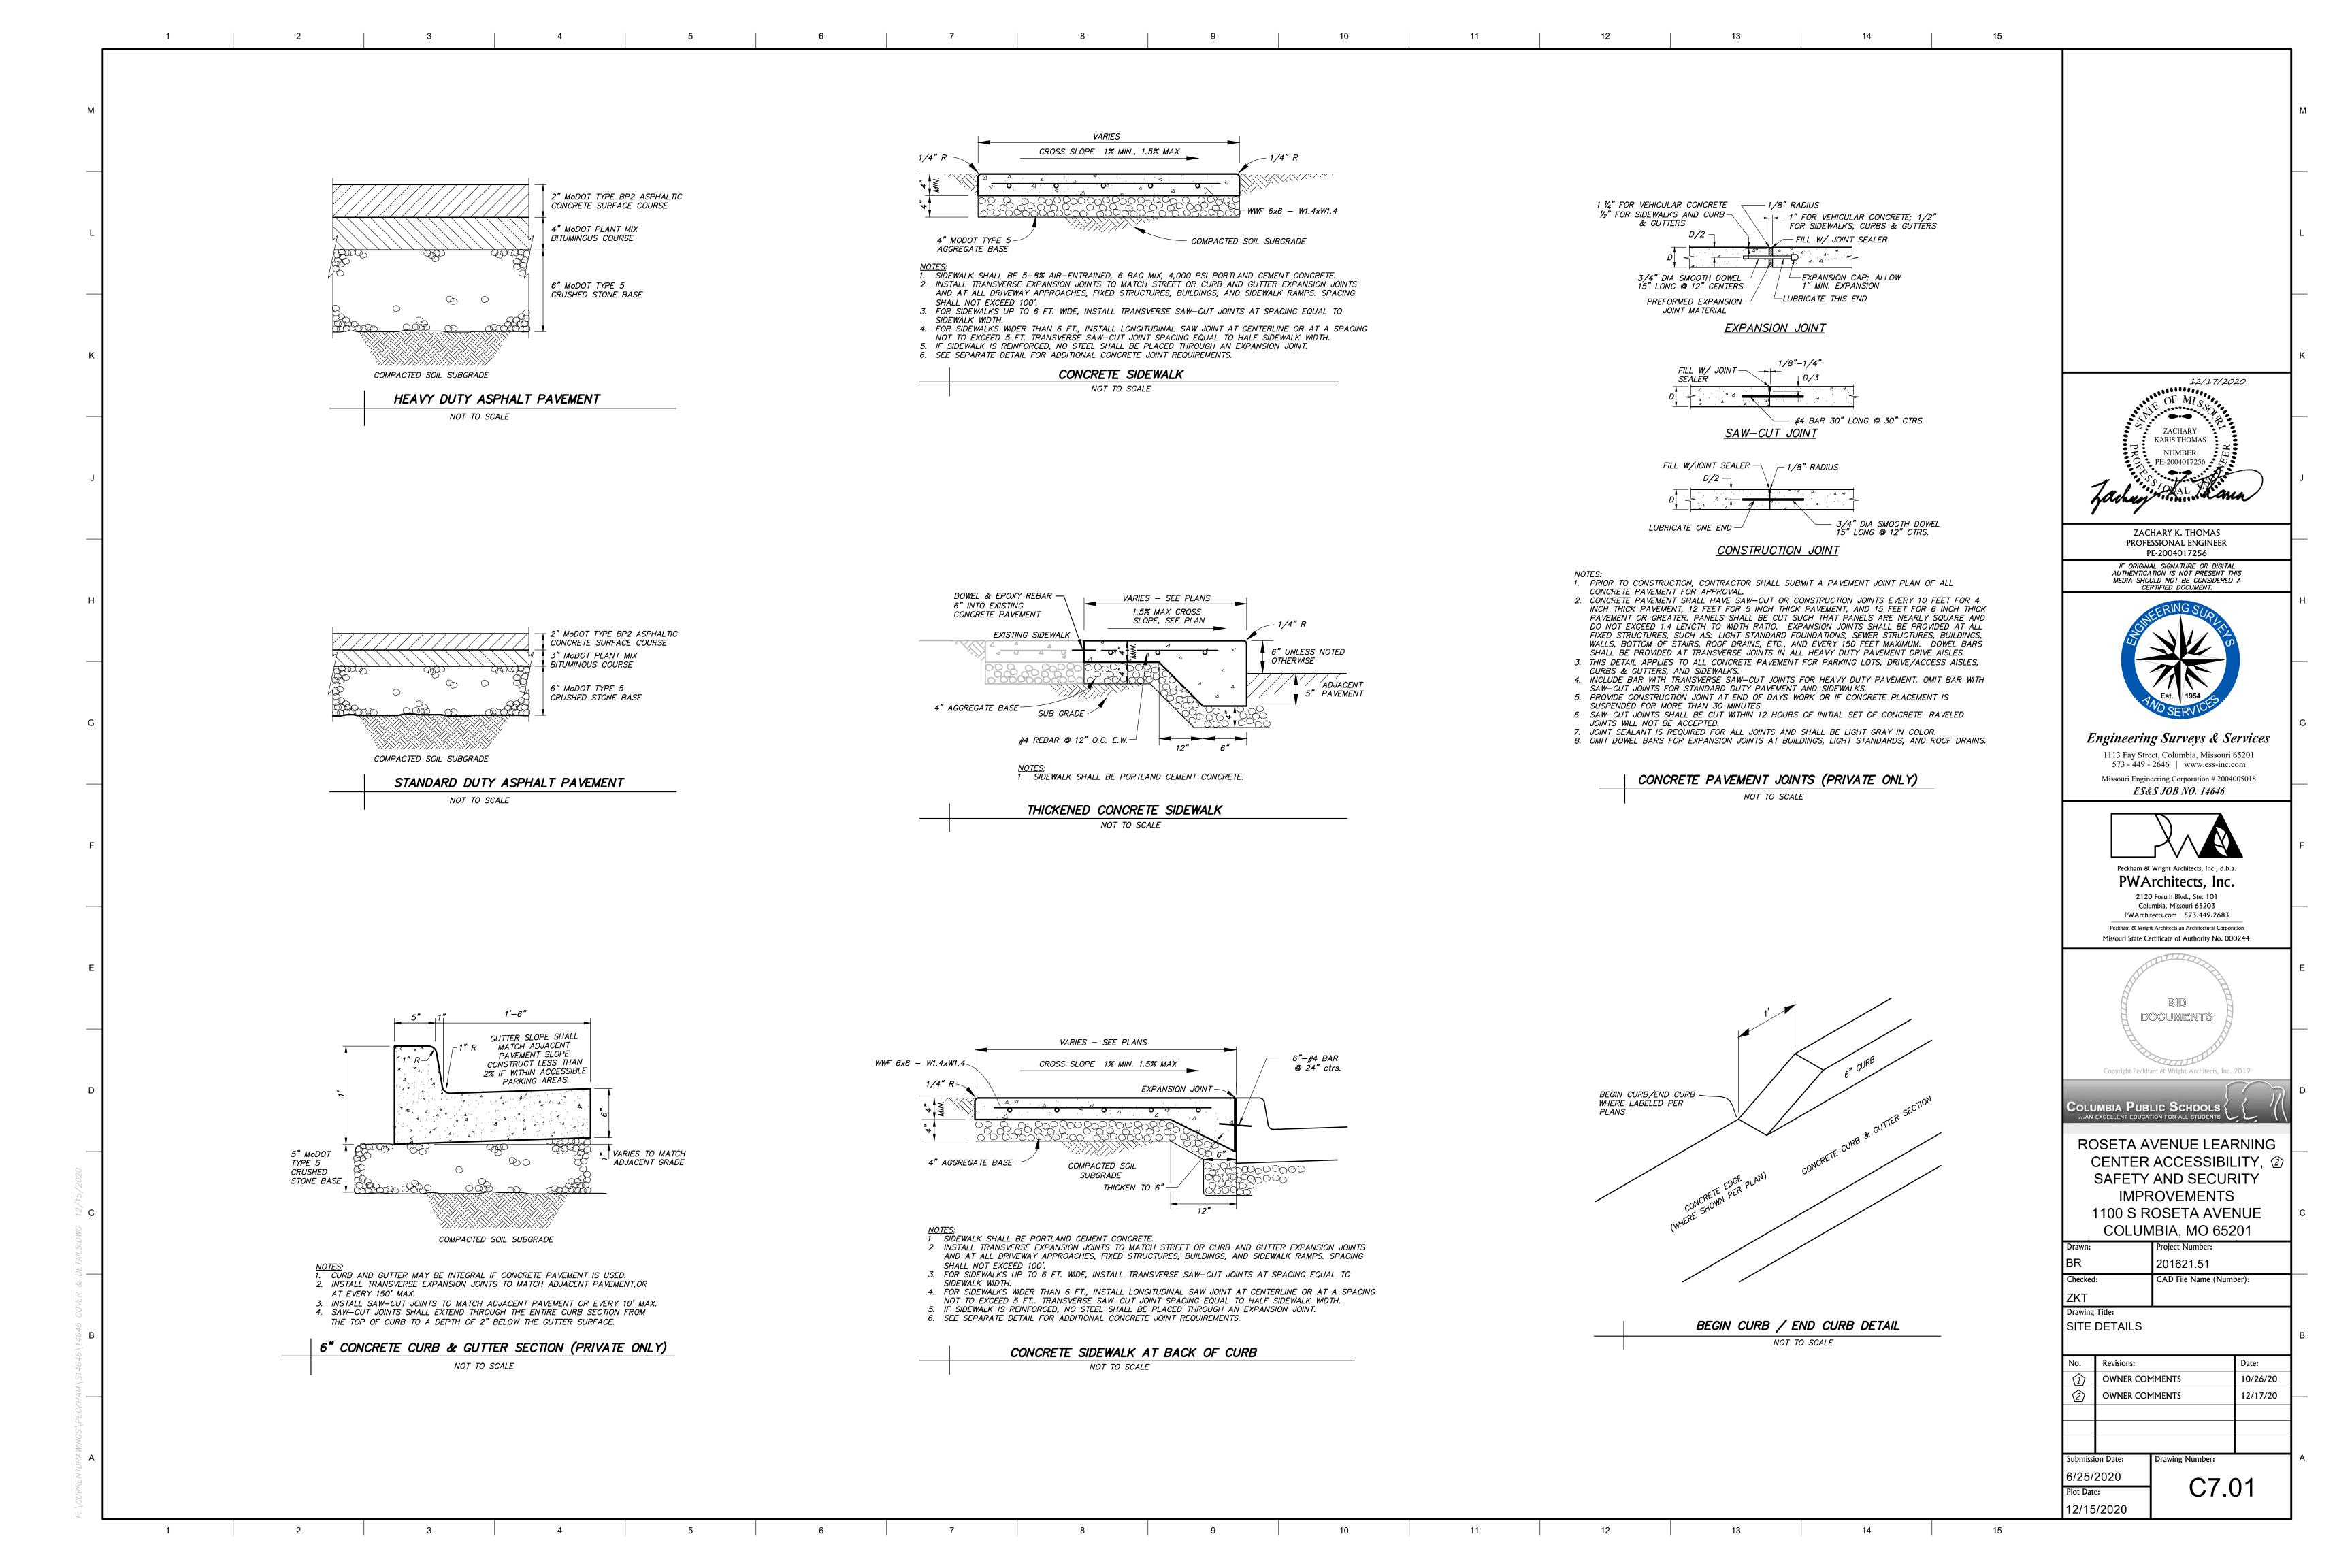


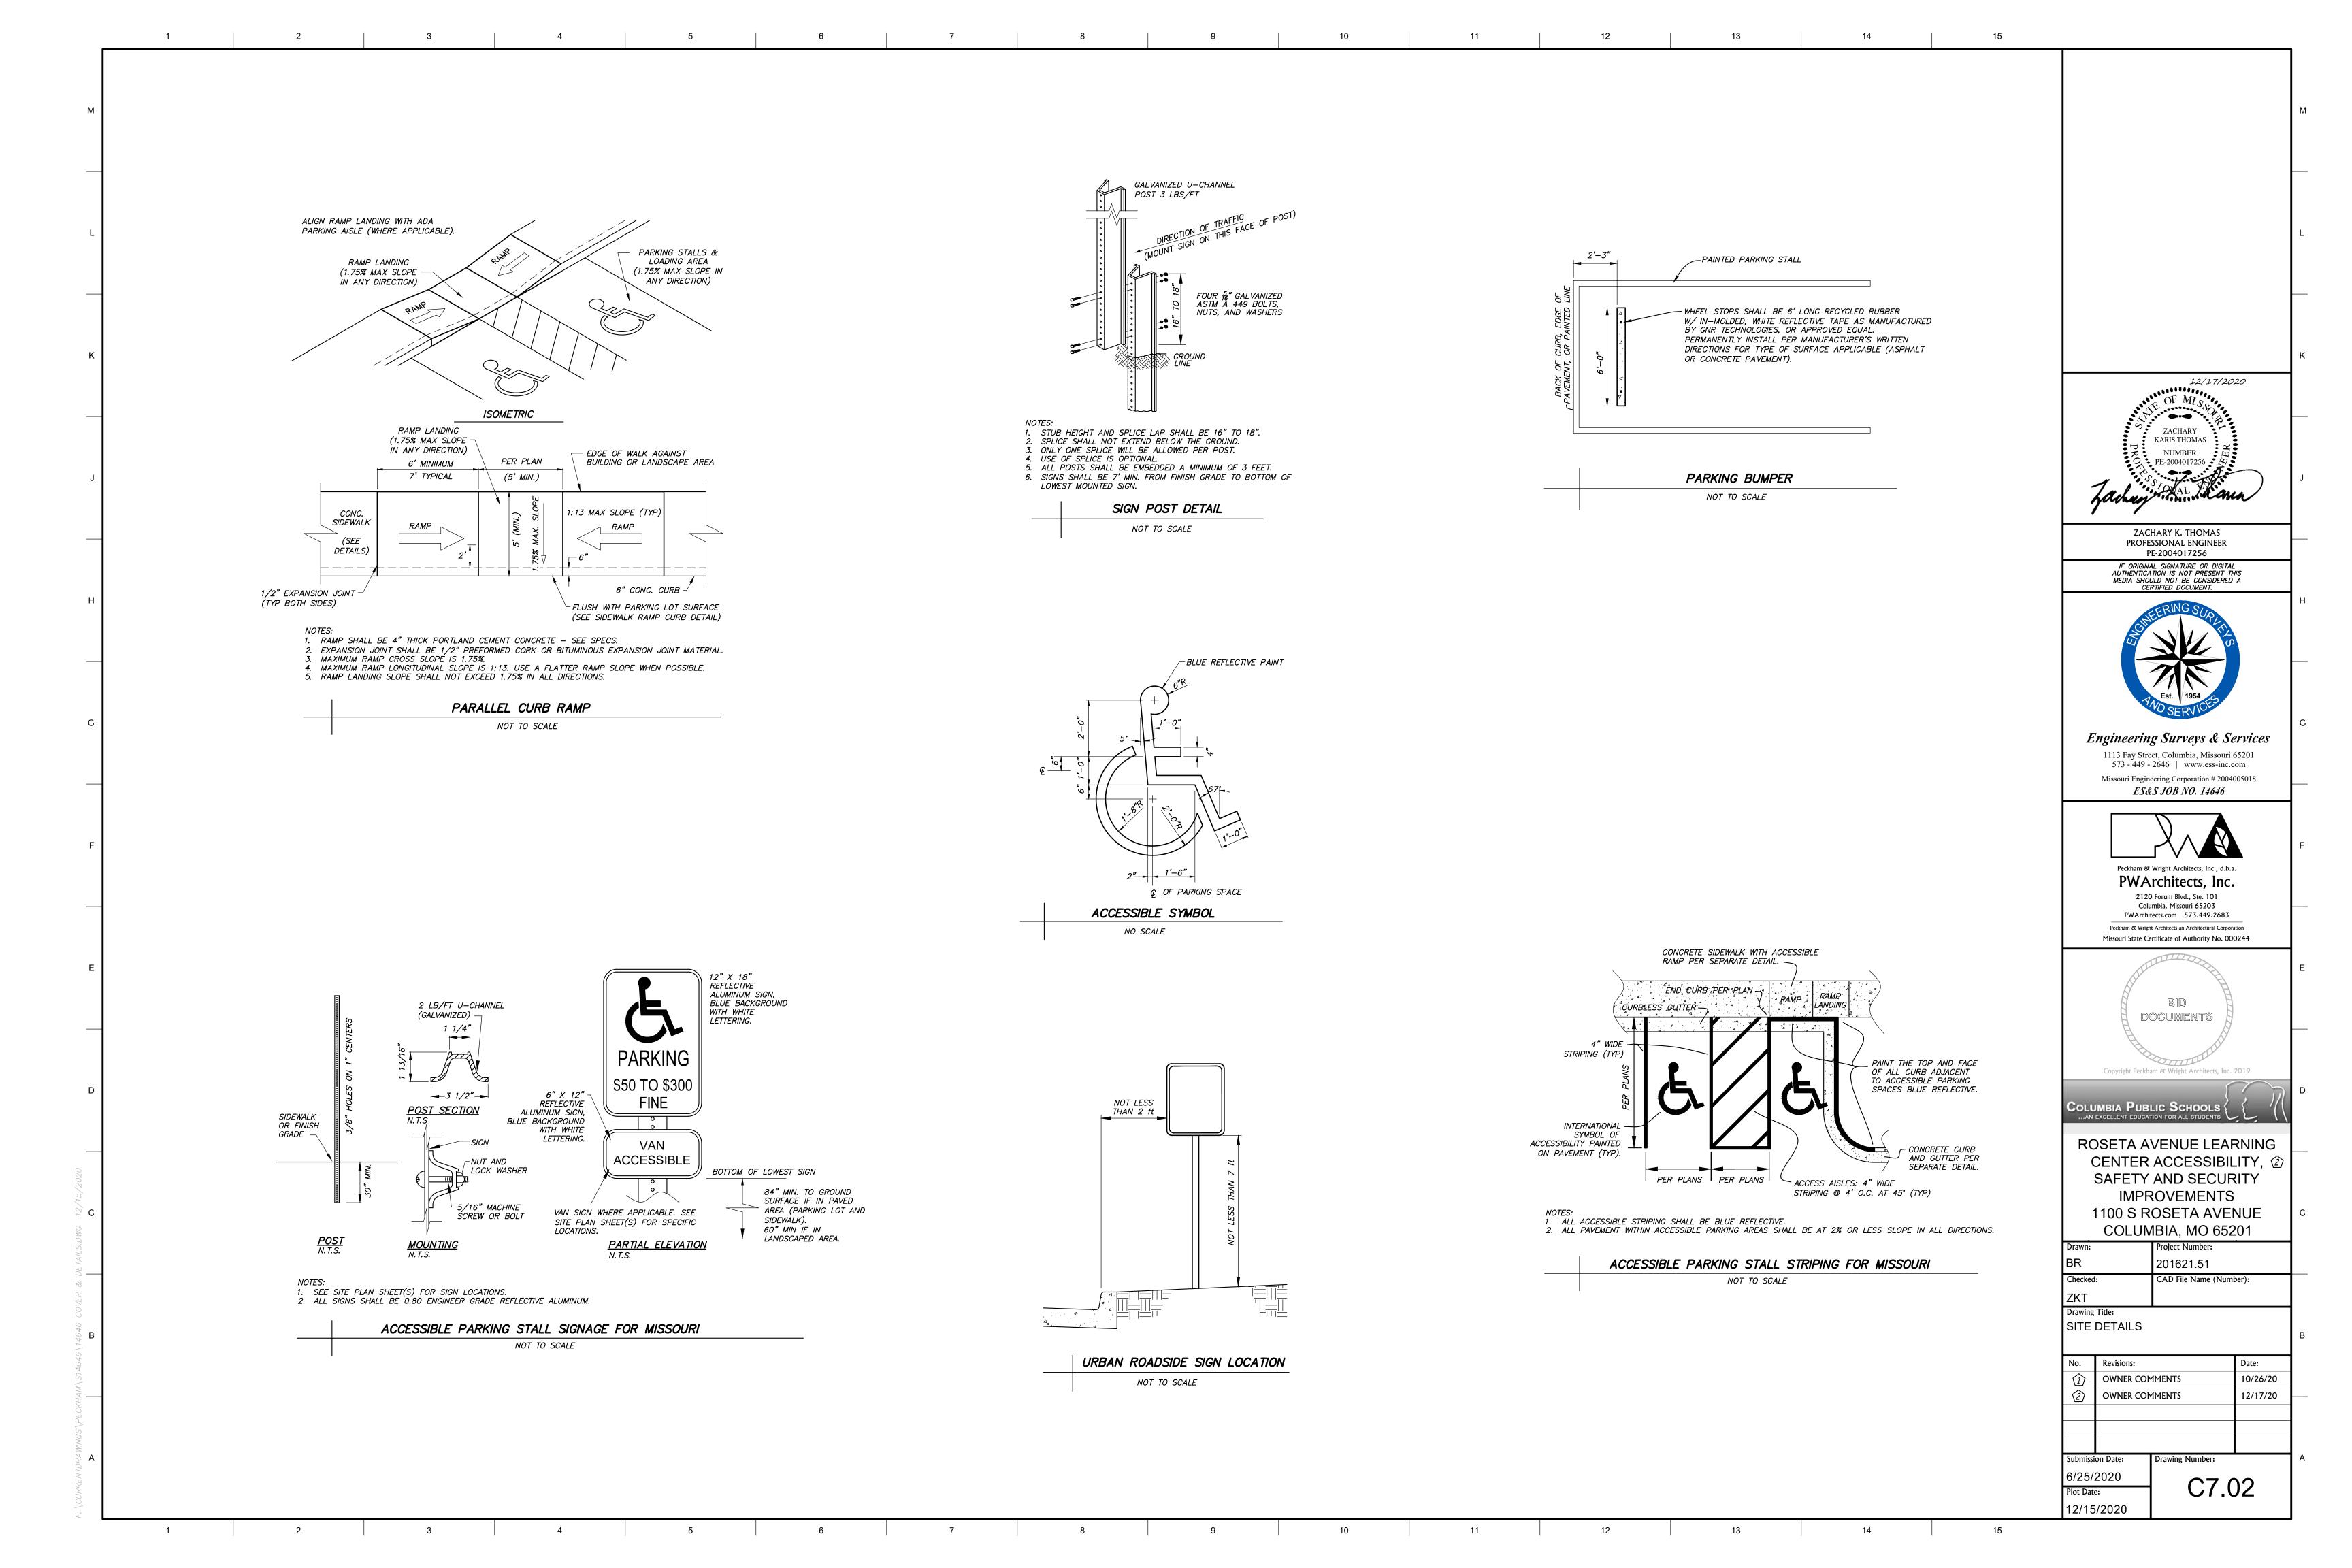


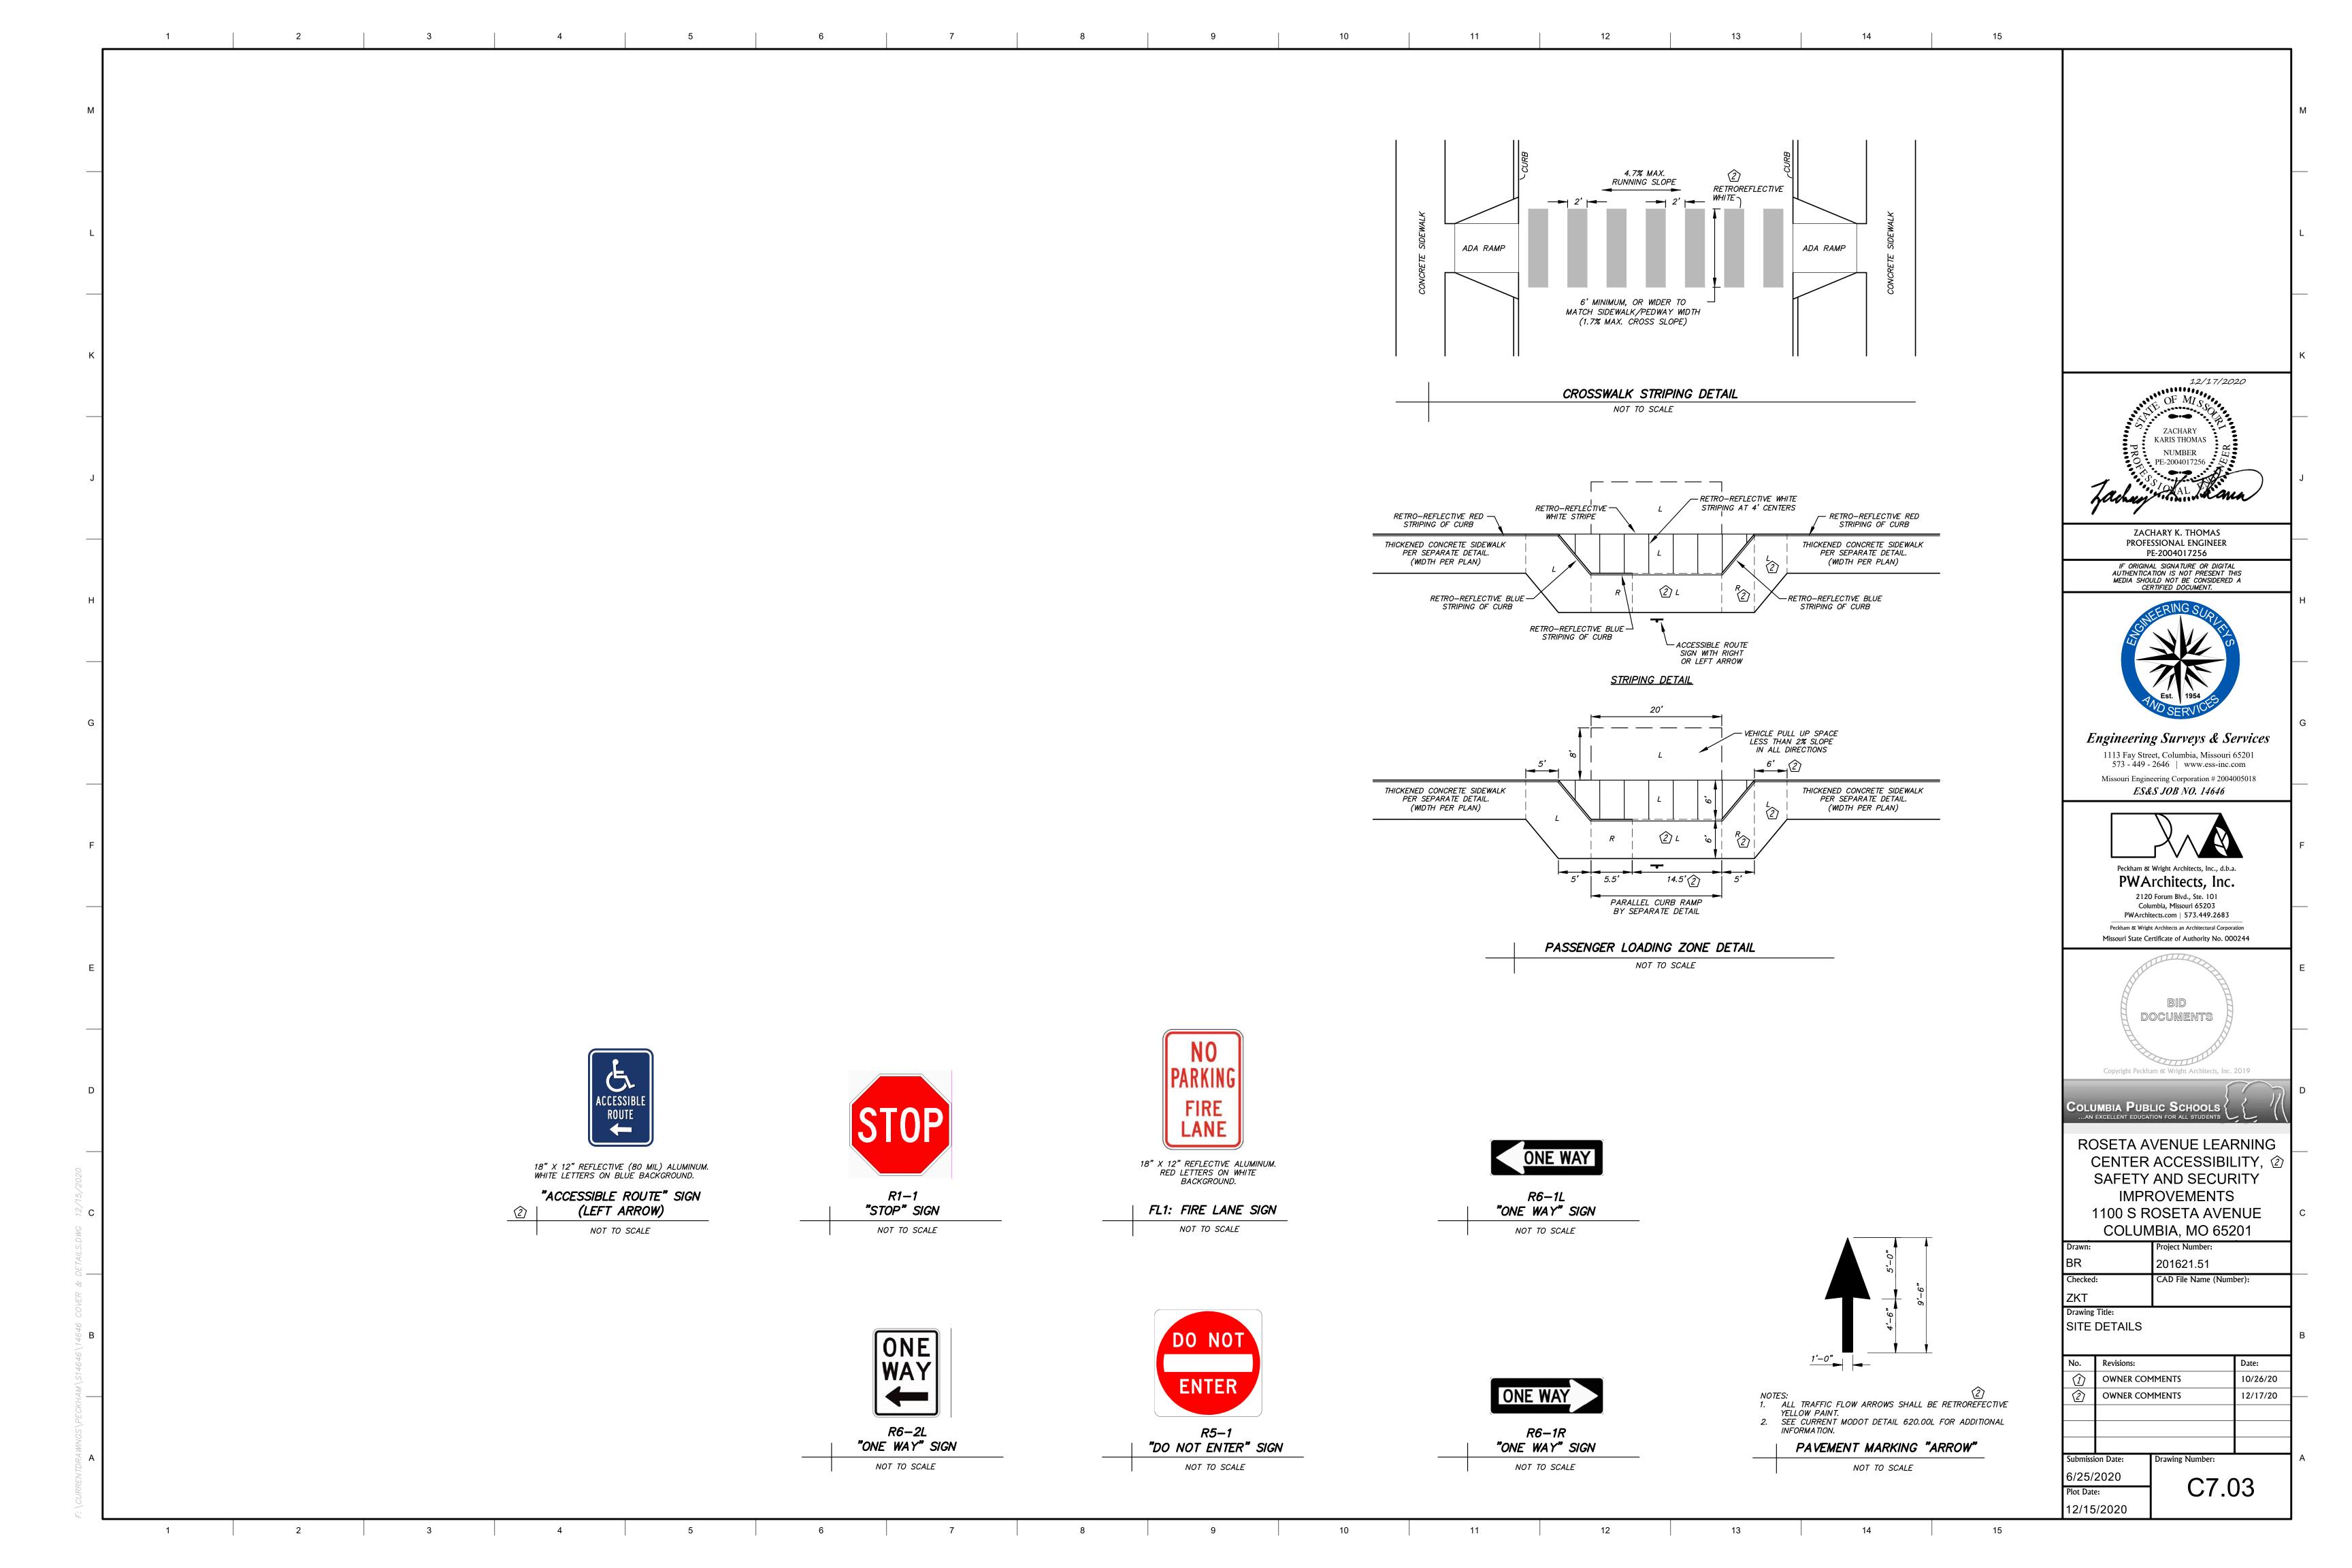

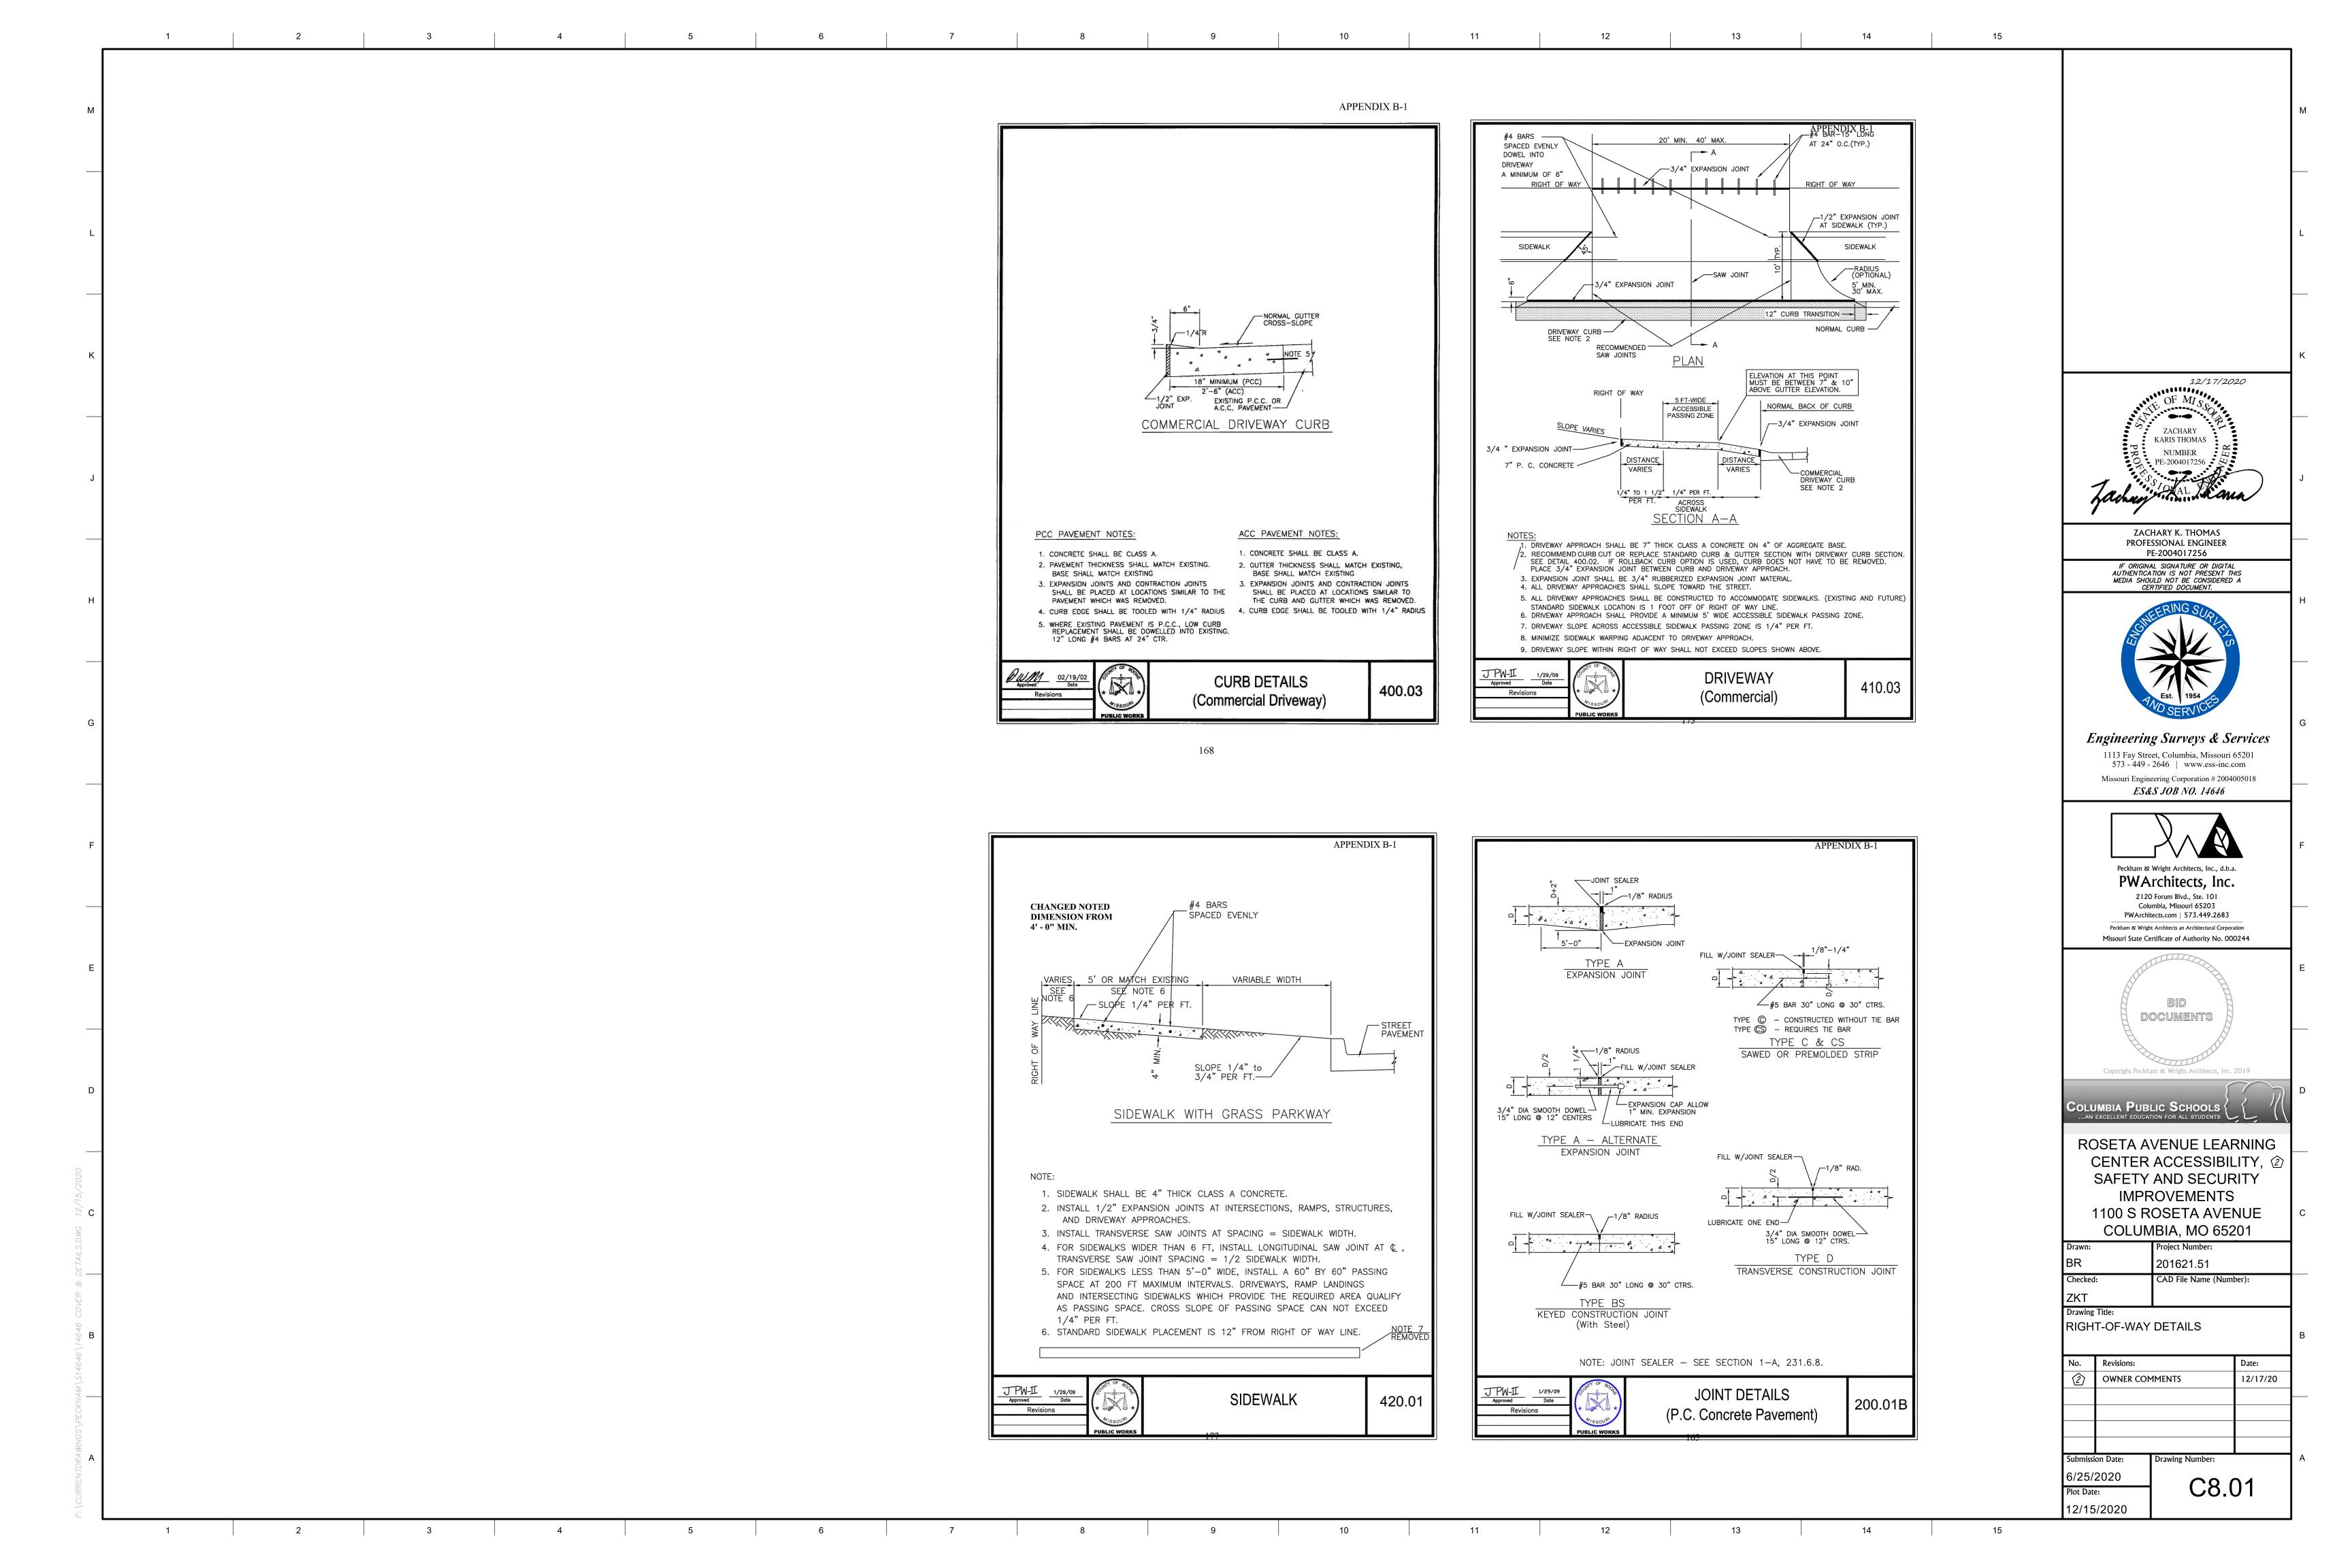

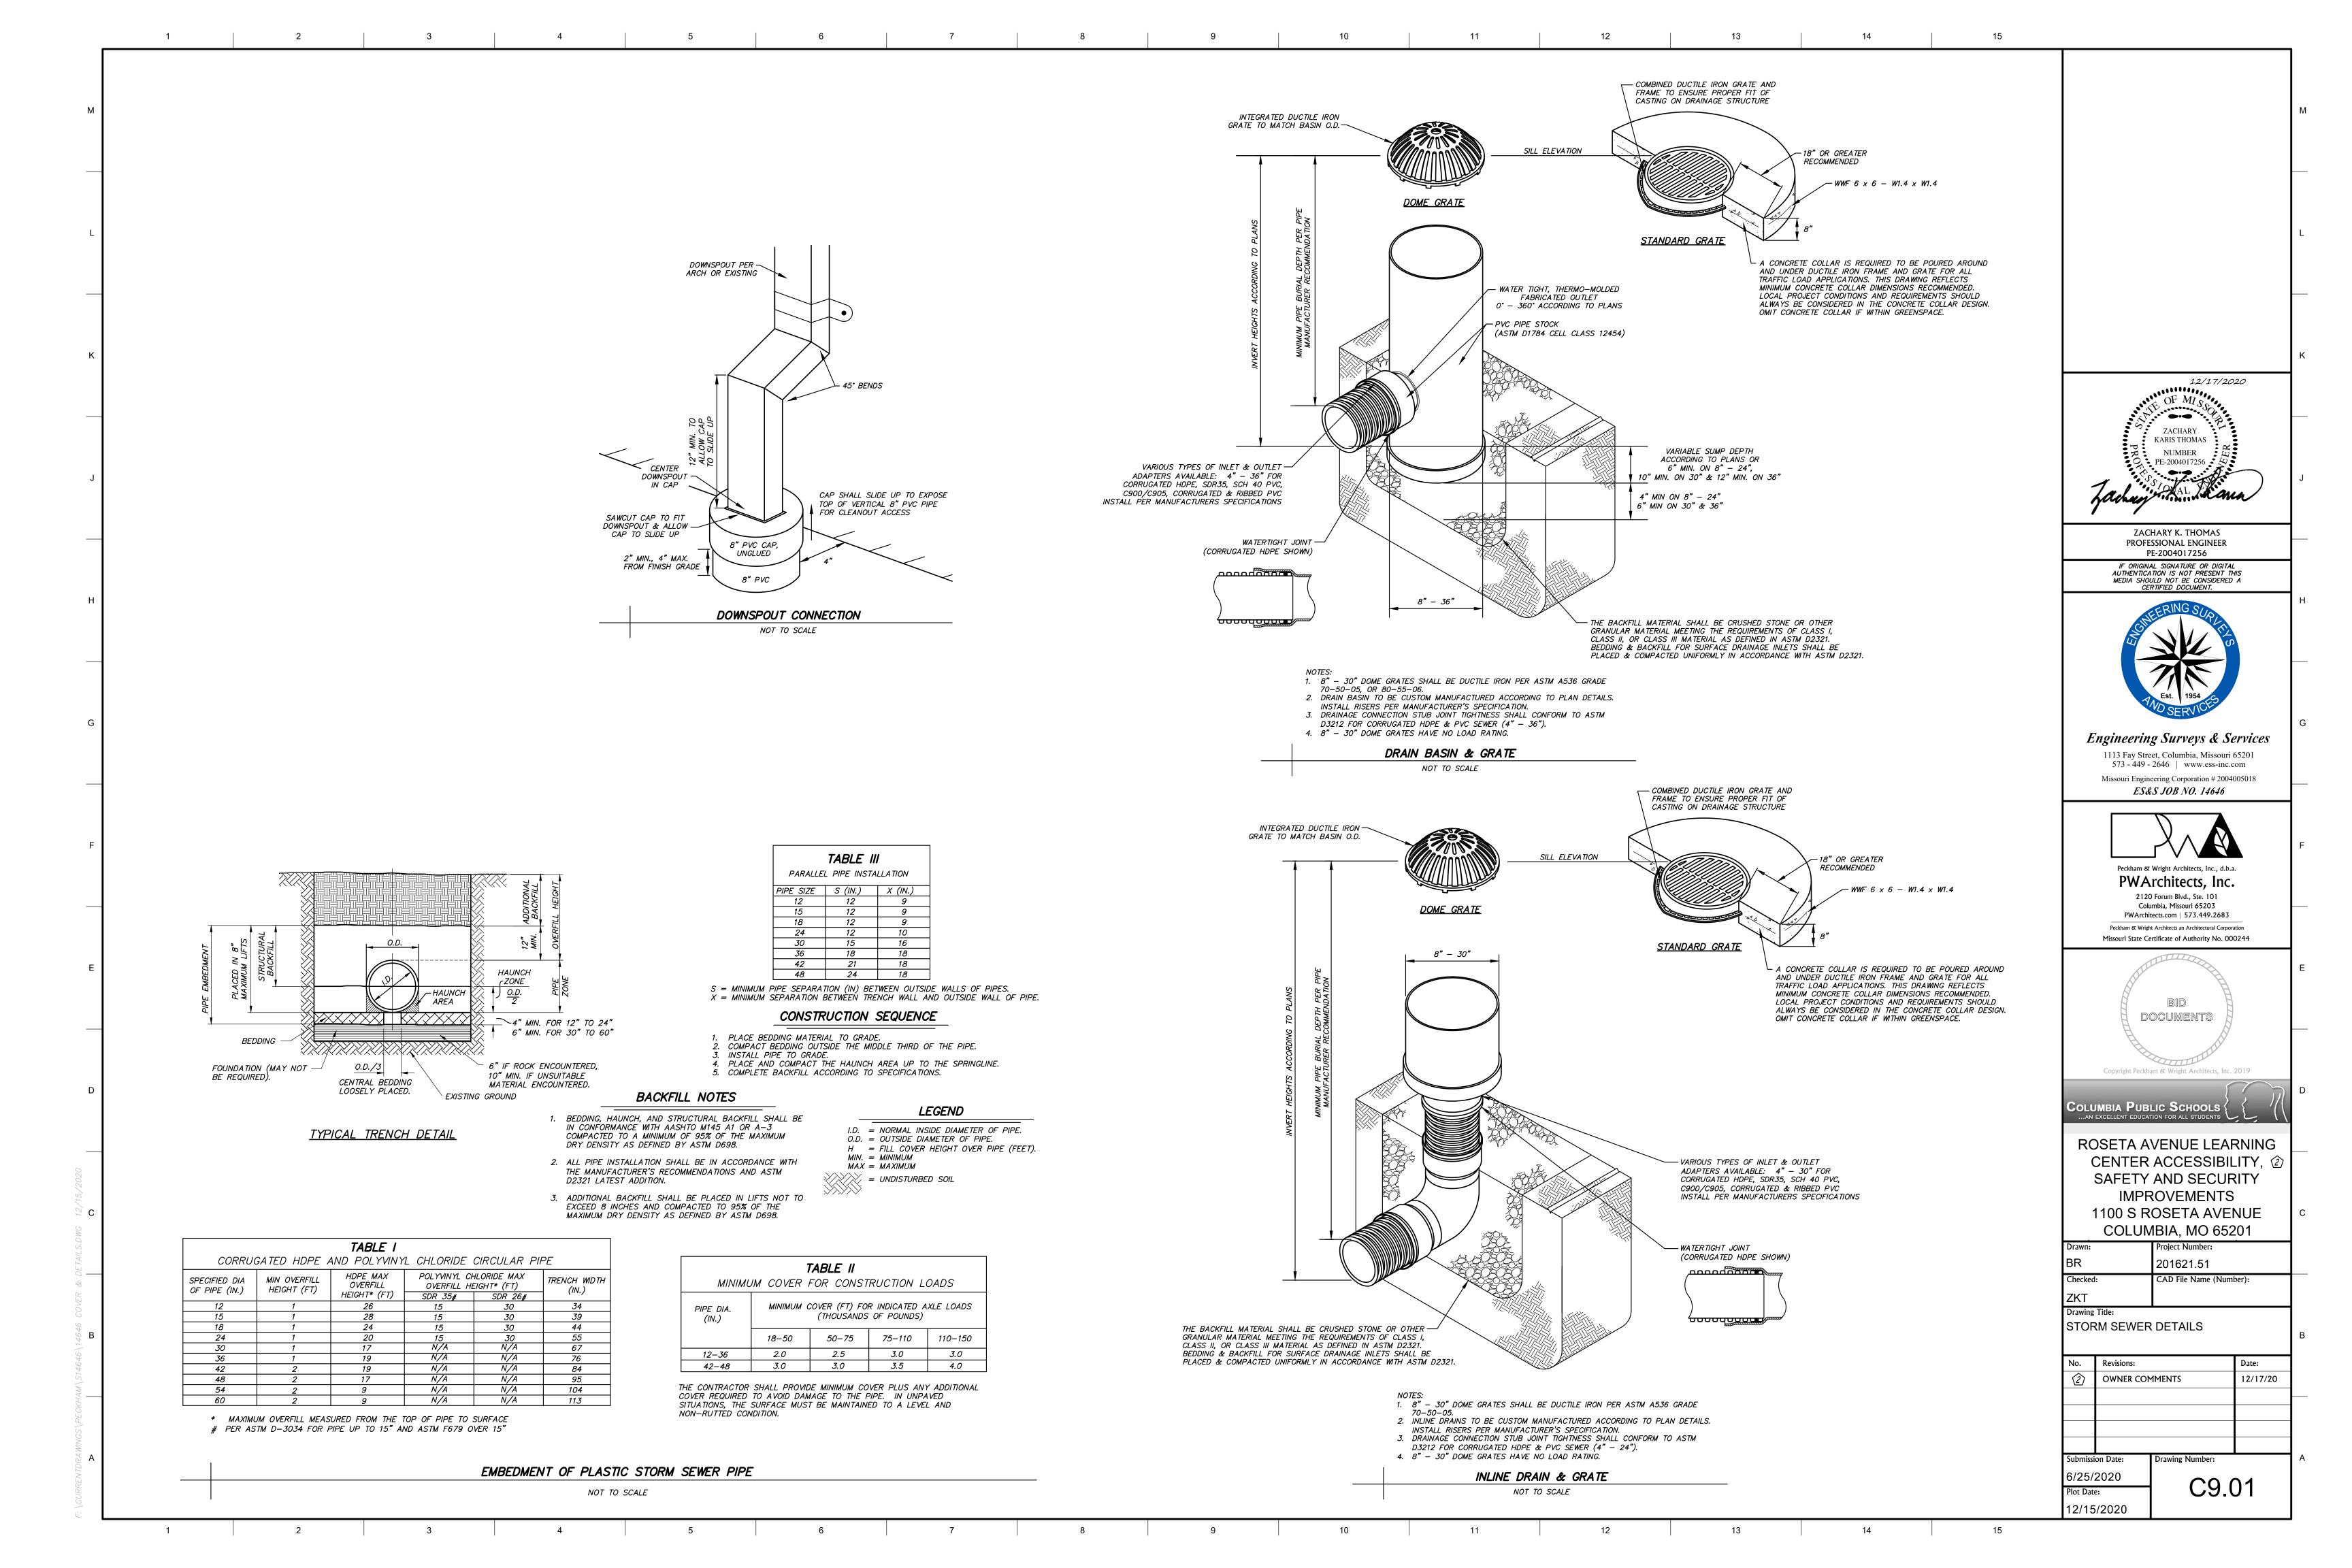

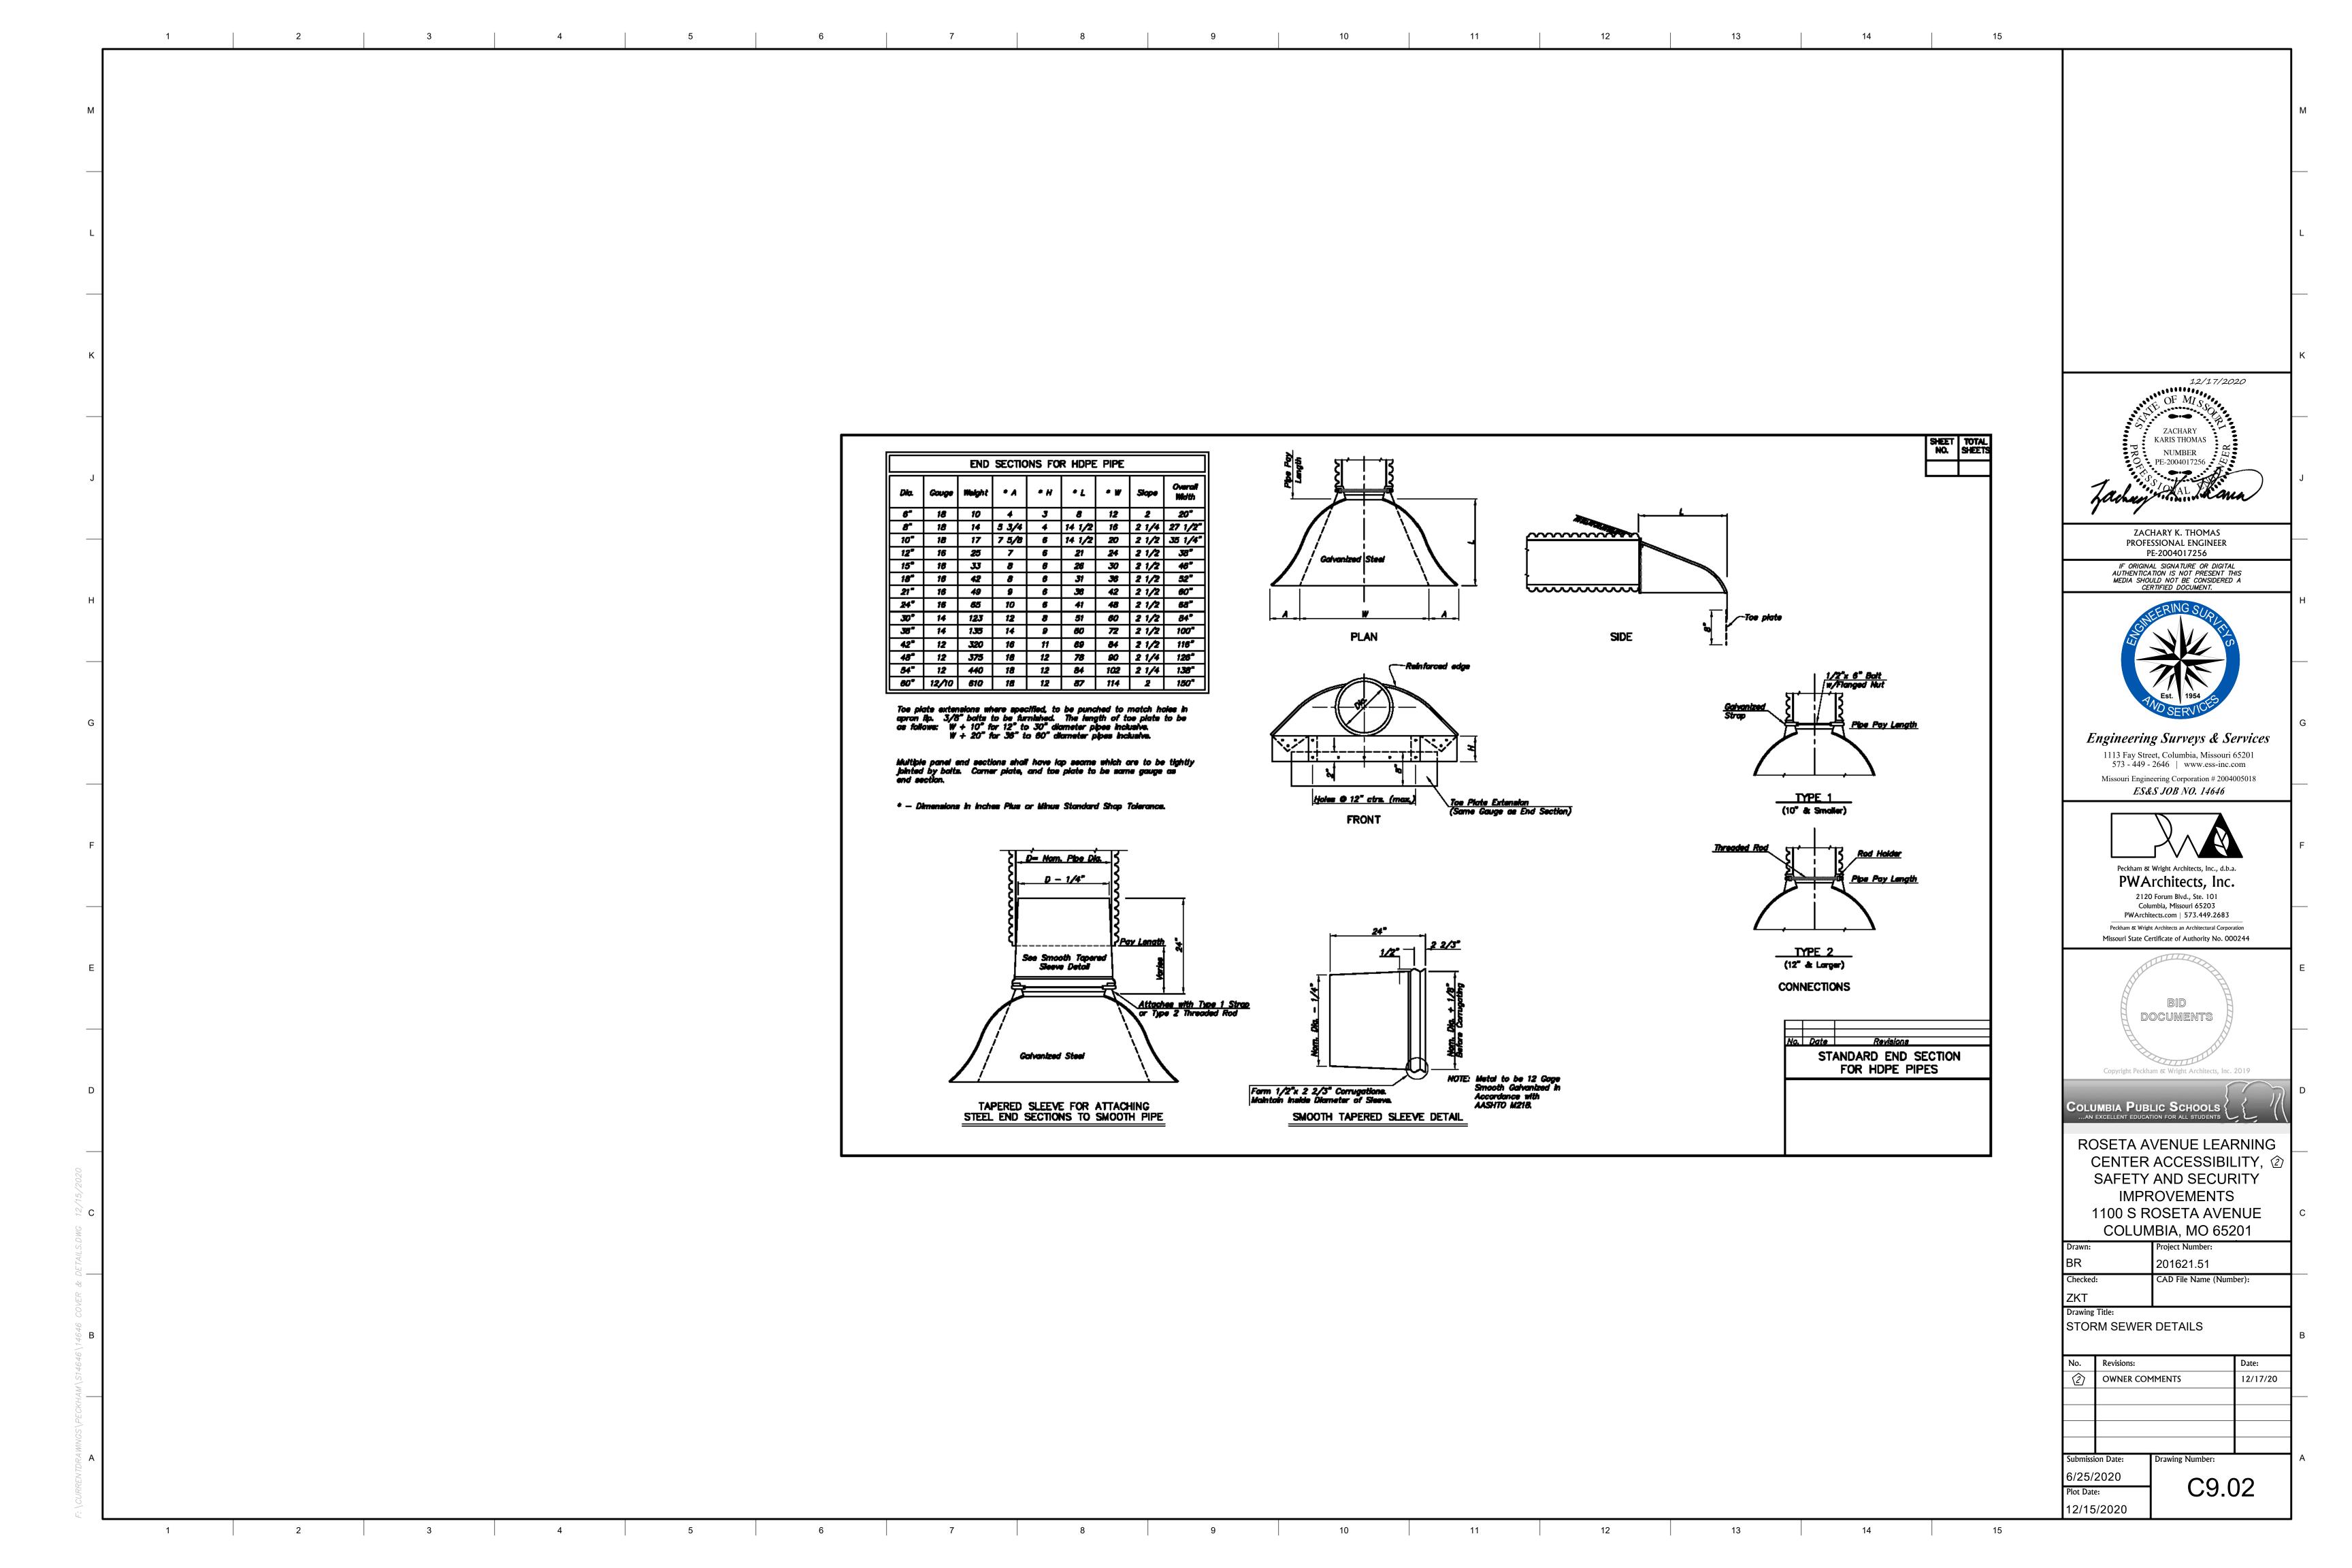

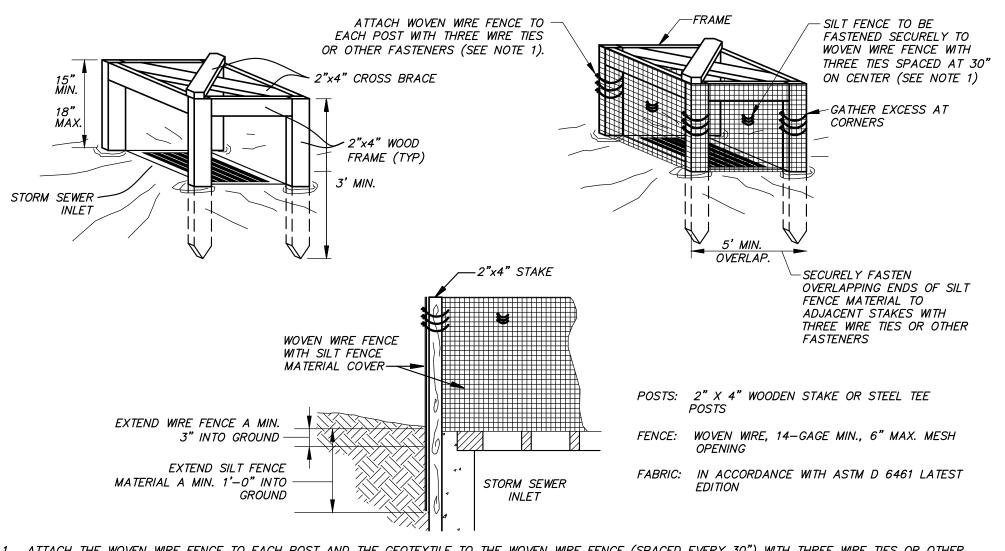


1. ATTACH THE WOVEN WIRE FENCE TO EACH POST AND THE GEOTEXTILE TO THE WOVEN WIRE FENCE (SPACED EVERY 30") WITH THREE WIRE TIES OR OTHER FASTENERS, ALL SPACED WITHIN THE TOP 8" OF THE FABRIC. ATTACH EACH TIE DIAGONALLY 45 DEGREES THROUGH THE FABRIC, WITH EACH PUNCTURE


2. WHEN TWO SECTIONS OF SILT FENCE MATERIAL ADJOIN EACH OTHER, THEY SHALL BE OVERLAPPED ACROSS TWO POSTS.
3. MAINTENANCE SHALL BE PERFORMED AS NOTED IN THE SWPPP. DEPTH OF ACCUMULATED SEDIMENTS MAY NOT EXCEED ONE—THIRD THE HEIGHT OF THE FABRIC. MAINTENANCE CLEANING MUST BE CONDUCTED REGULARLY TO PREVENT ACCUMULATED SEDIMENTS FROM REACHING ONE-THIRD THE HEIGHT OF THE SILT FENCE MATERIAL. 4. ALL SILT FENCE SHALL INCLUDE WIRE SUPPORT.


SILT FENCE INLET PROTECTION


NOT TO SCALE

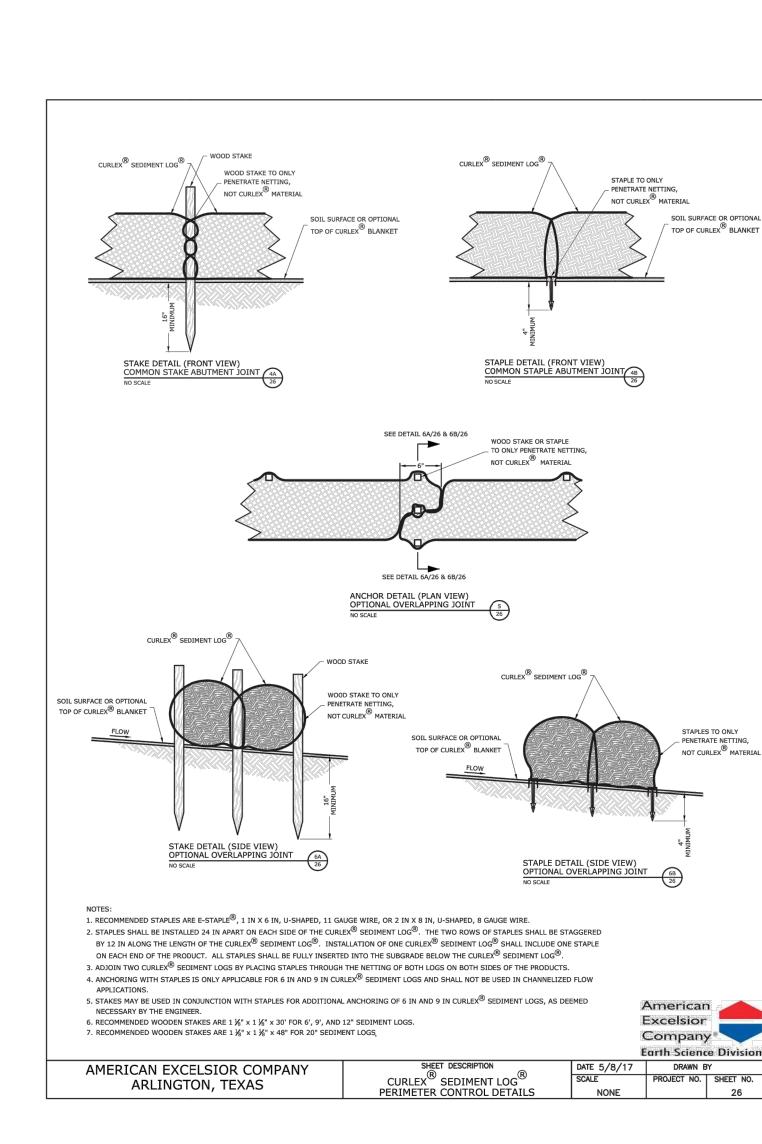


THE FENCE.

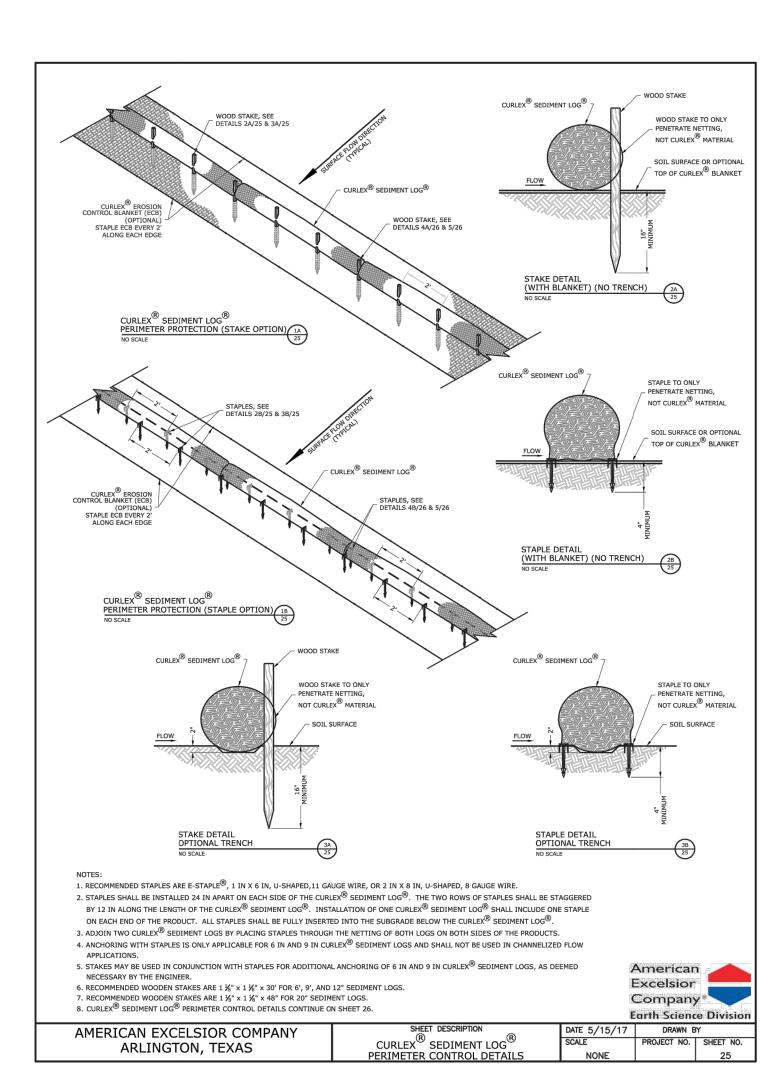


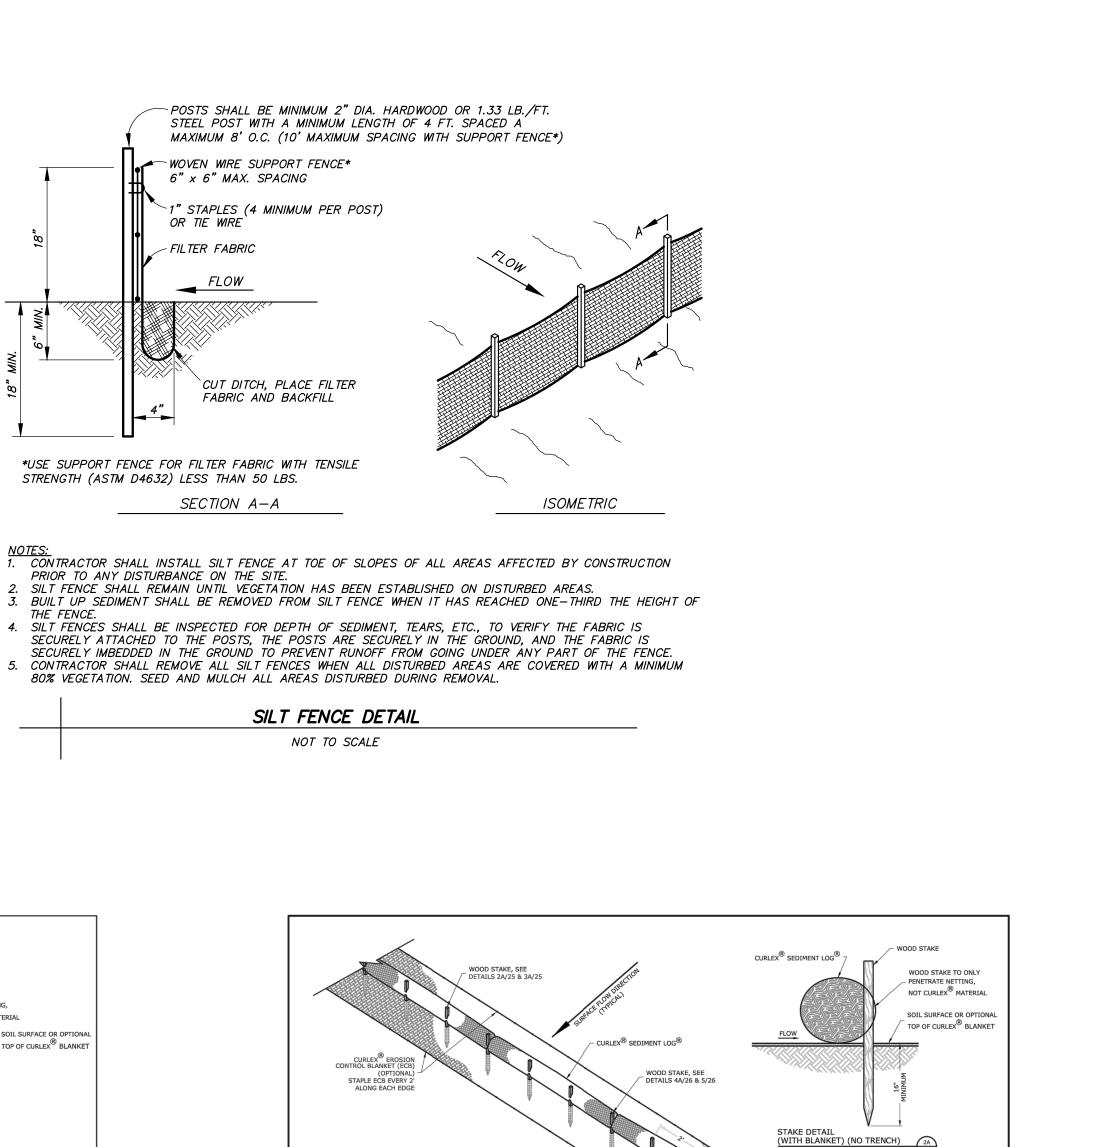


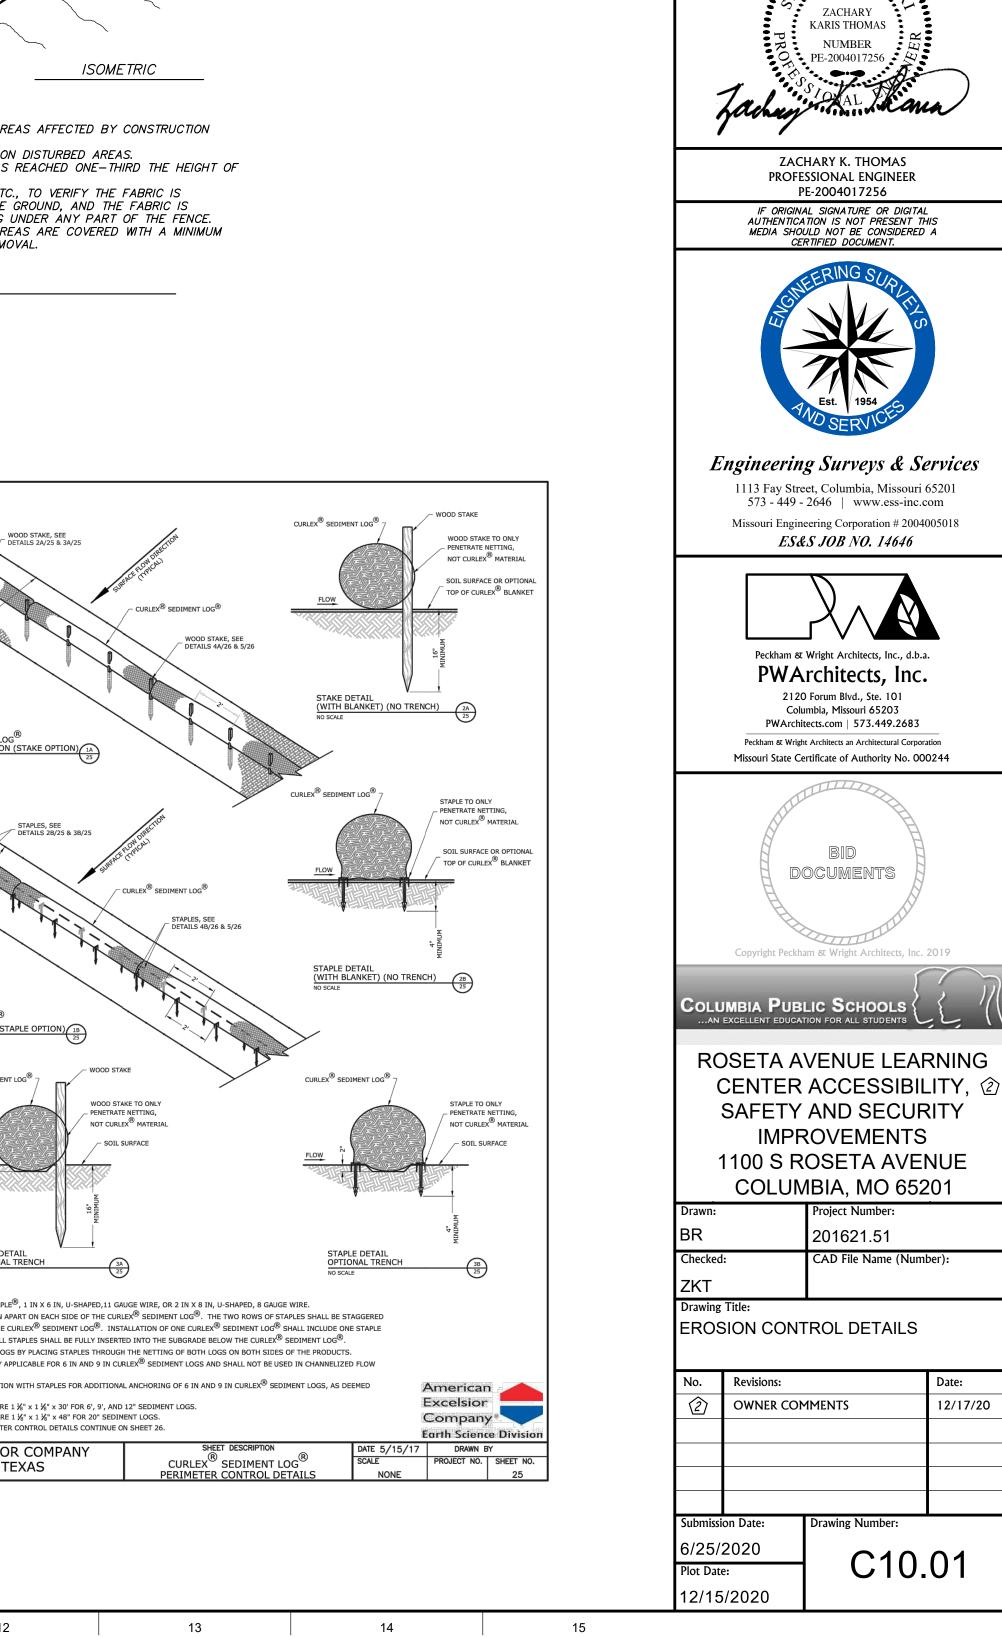



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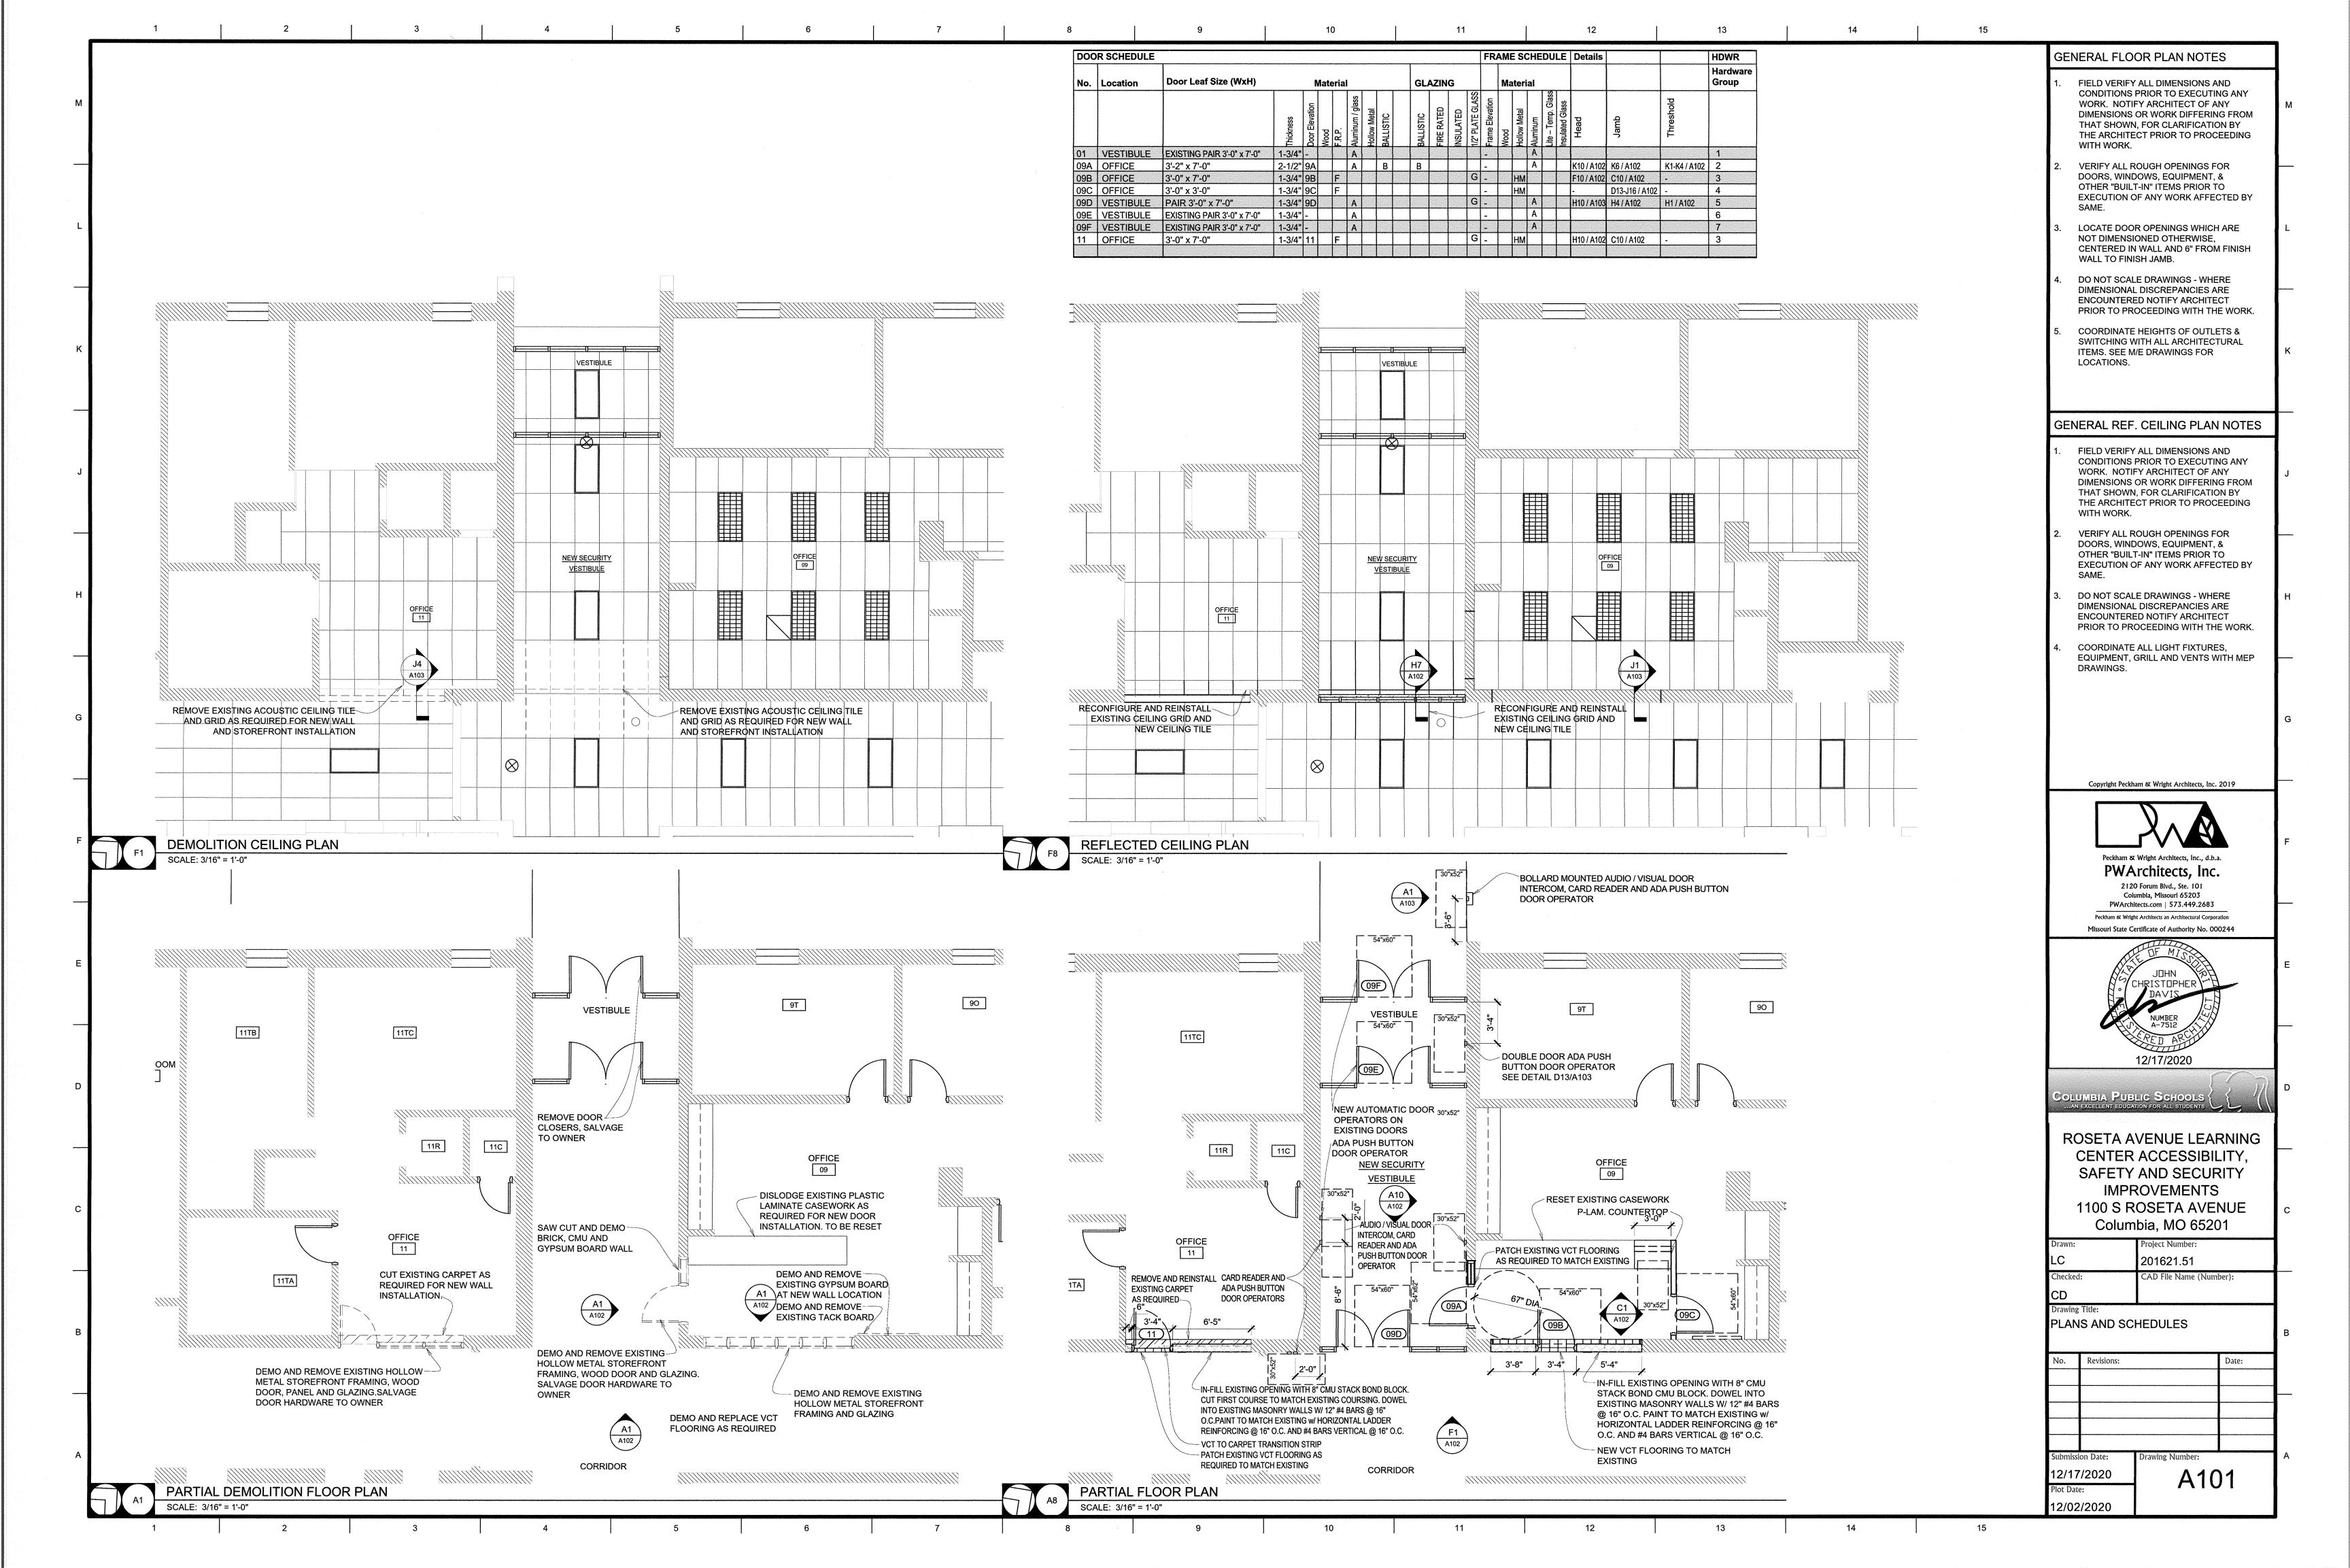


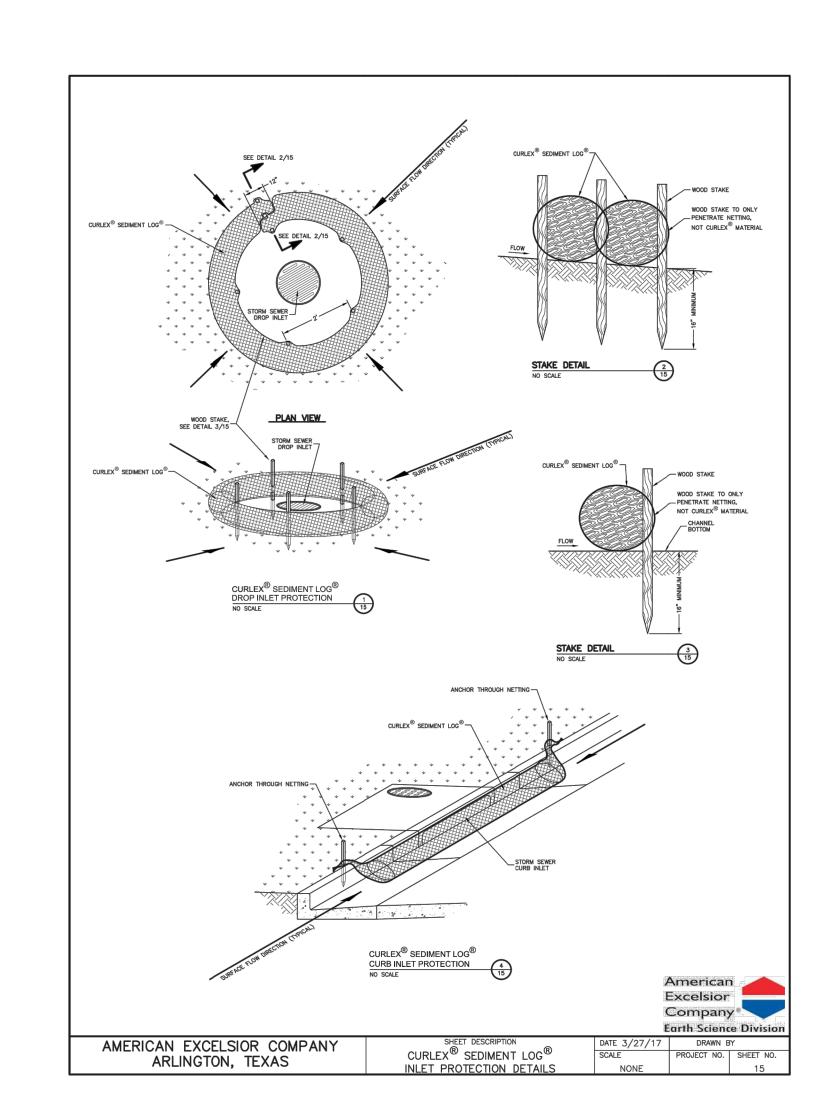


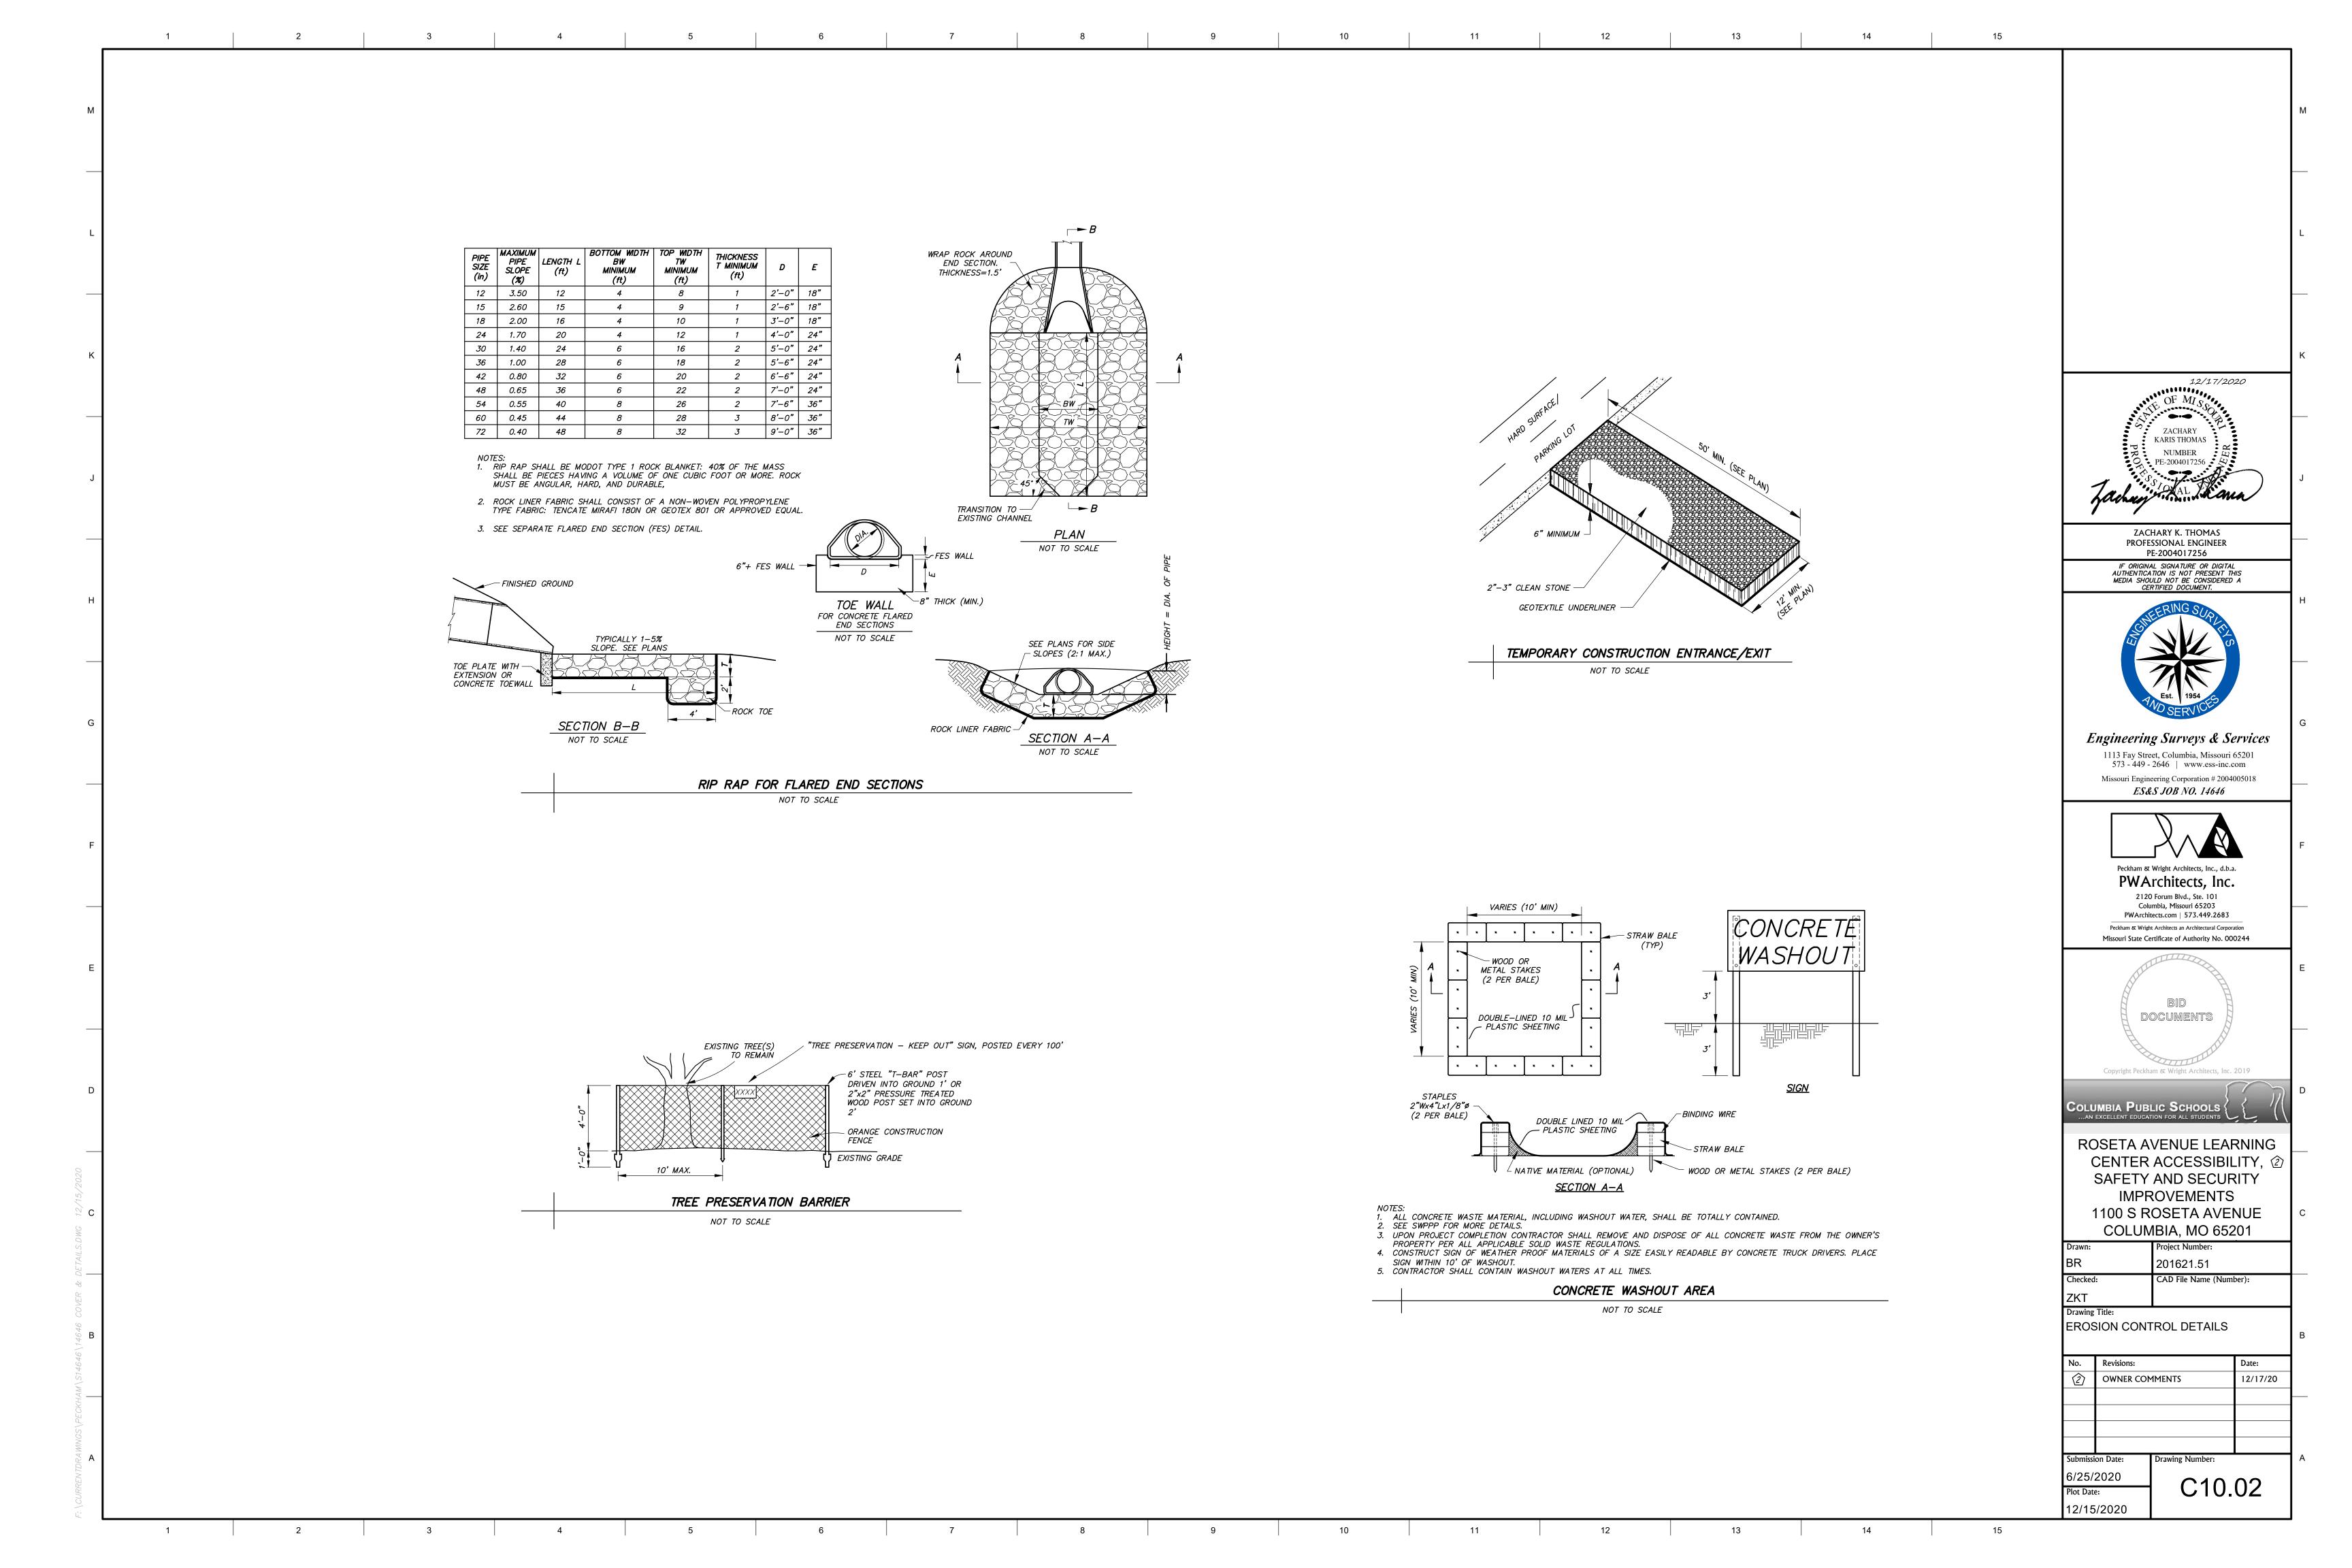


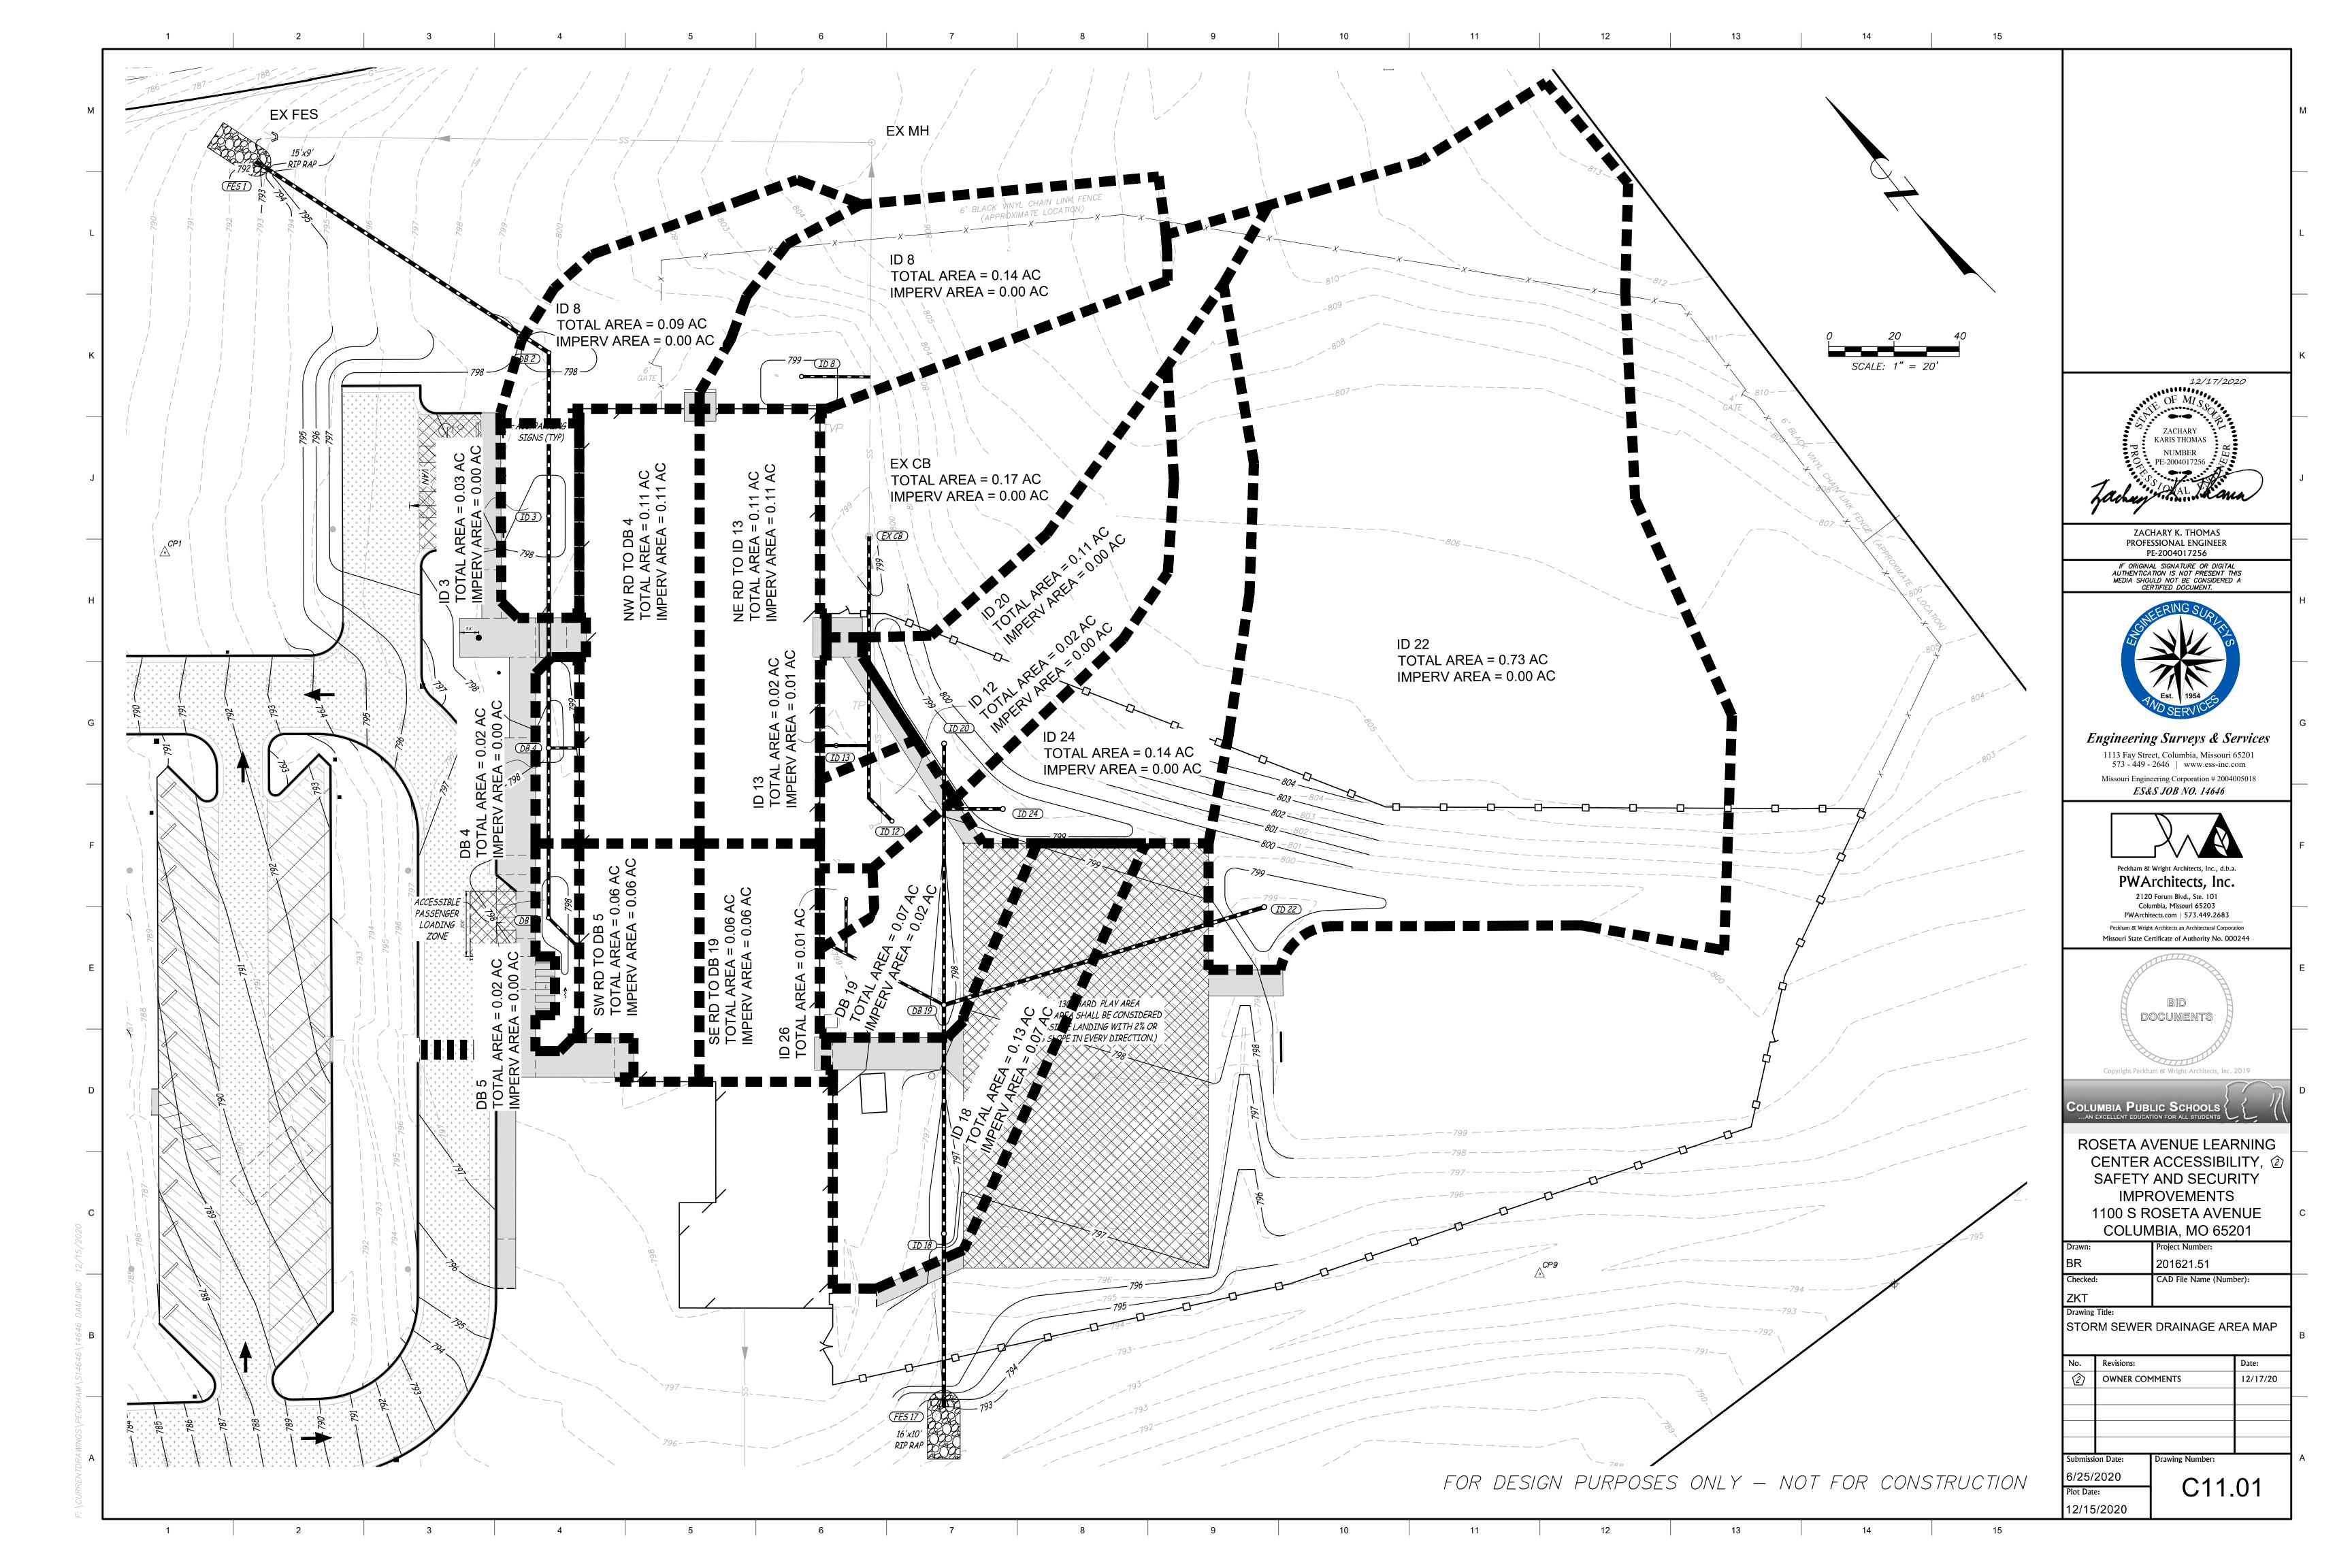

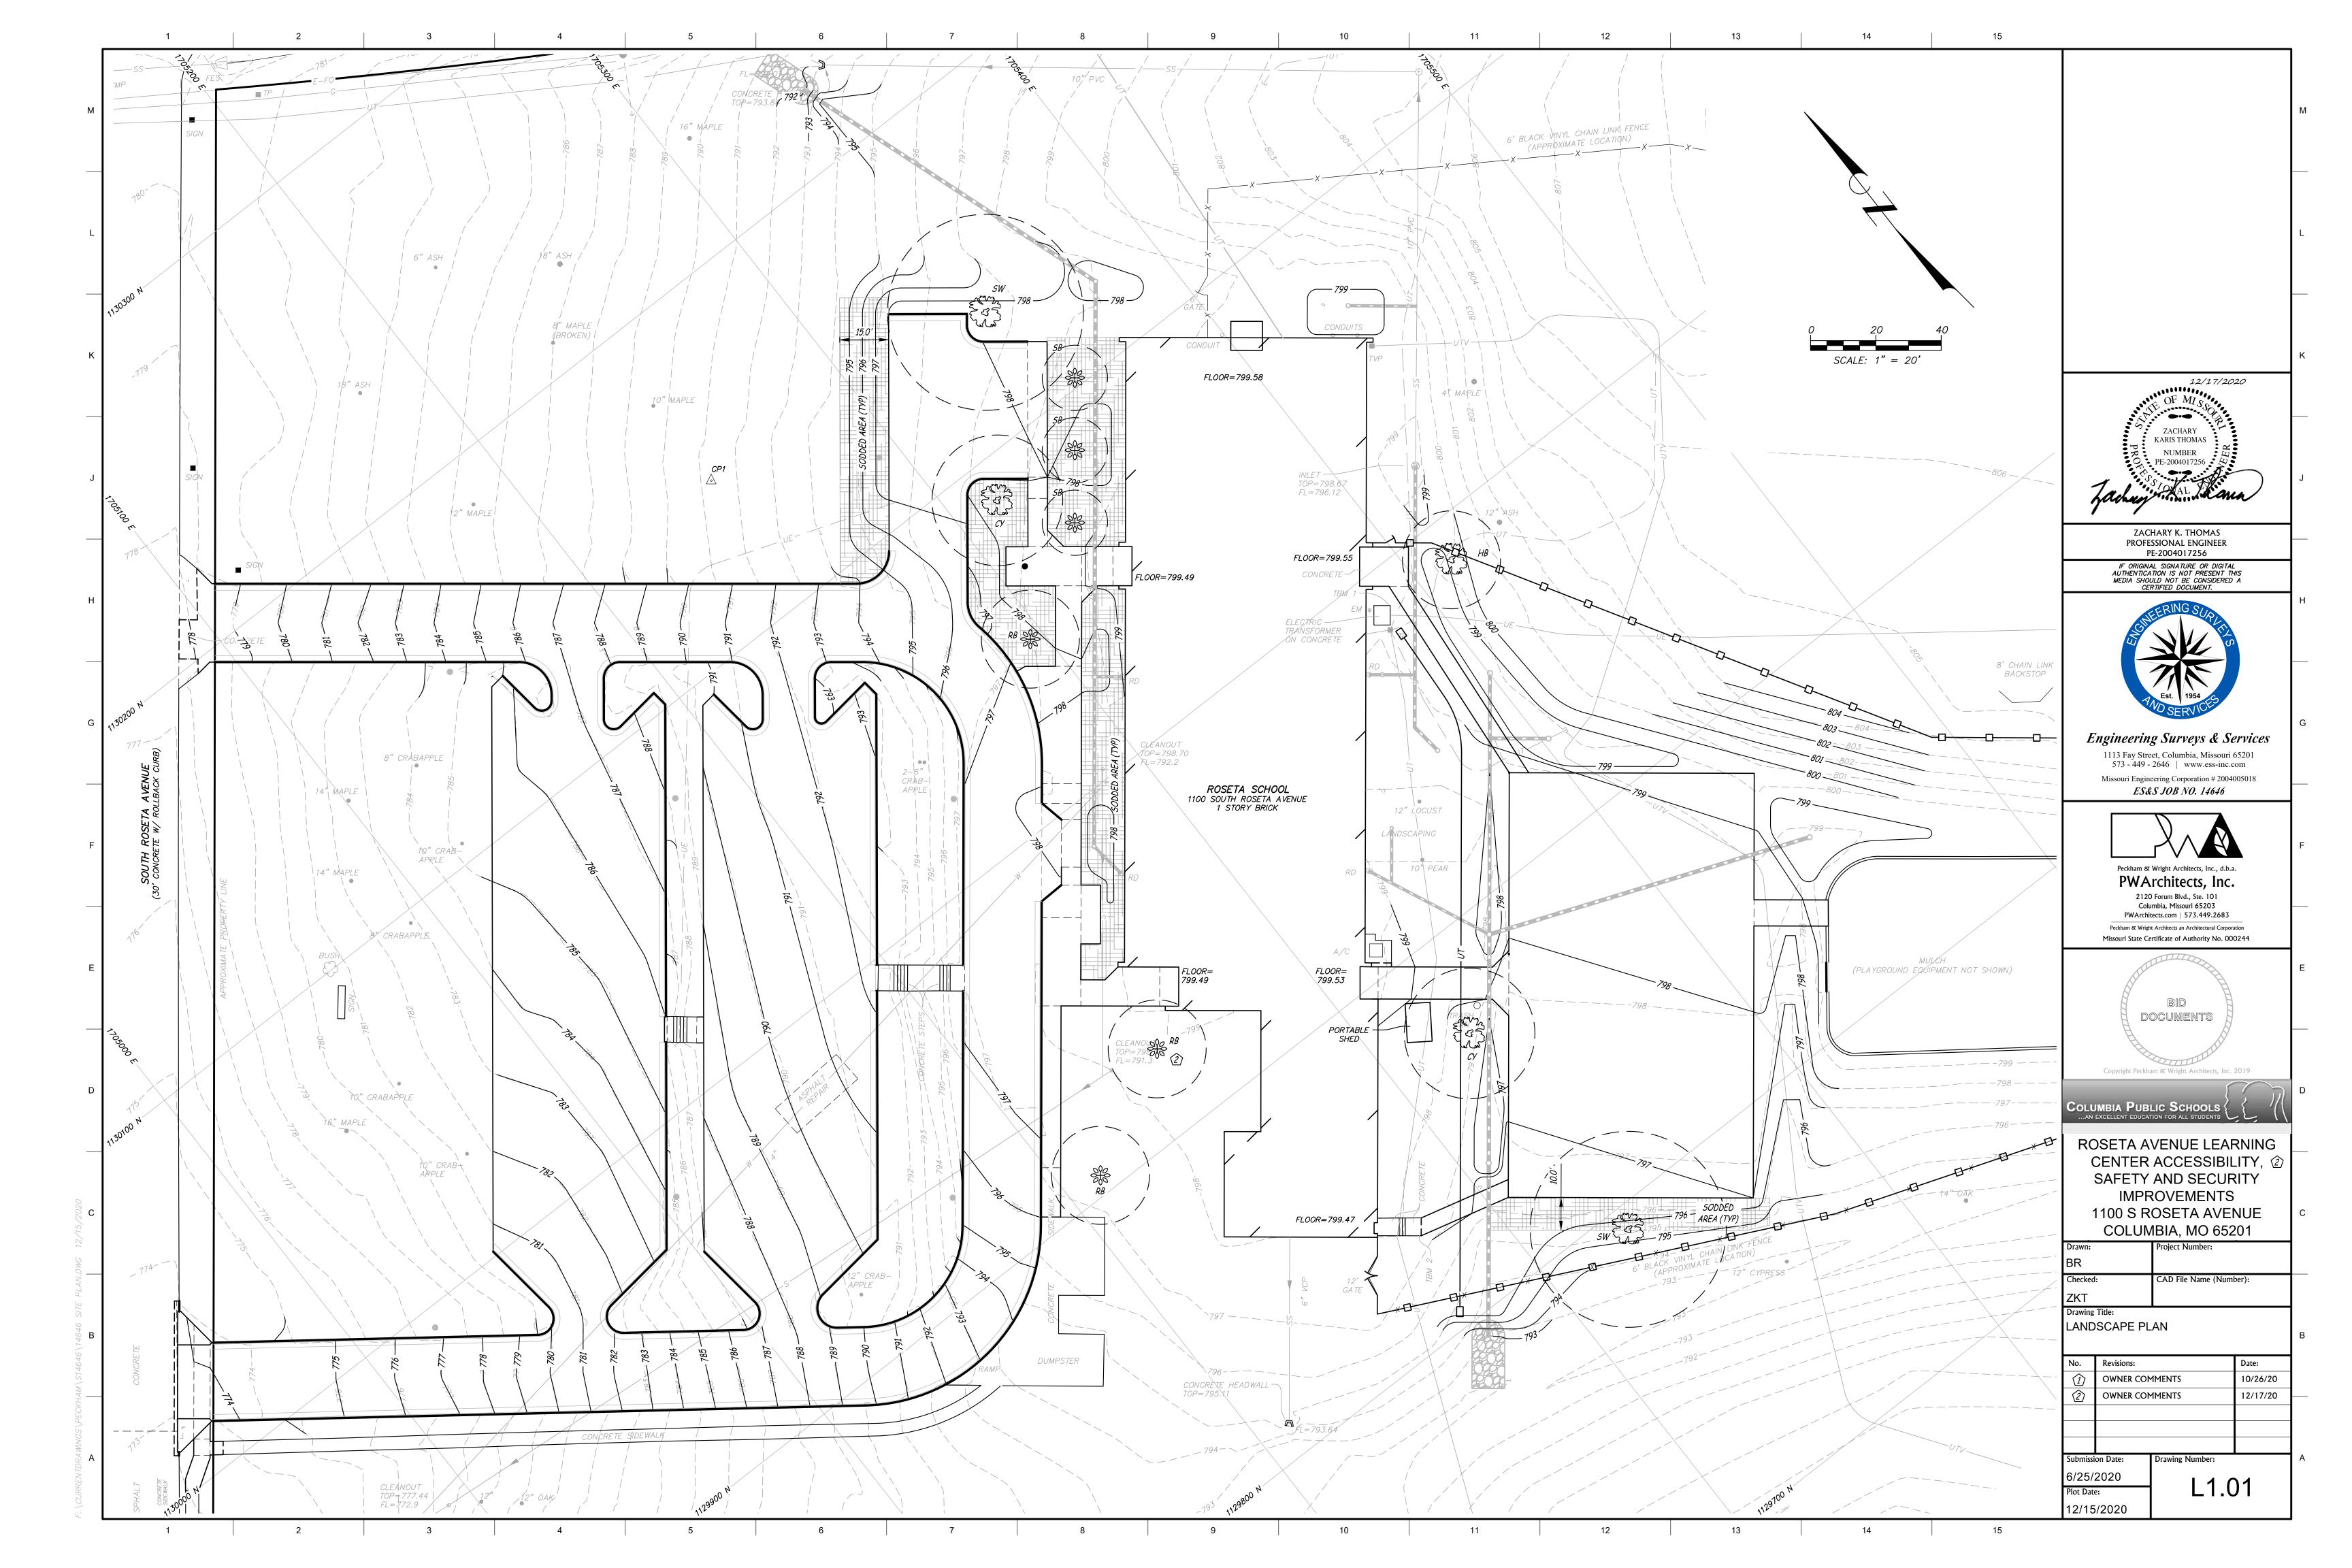

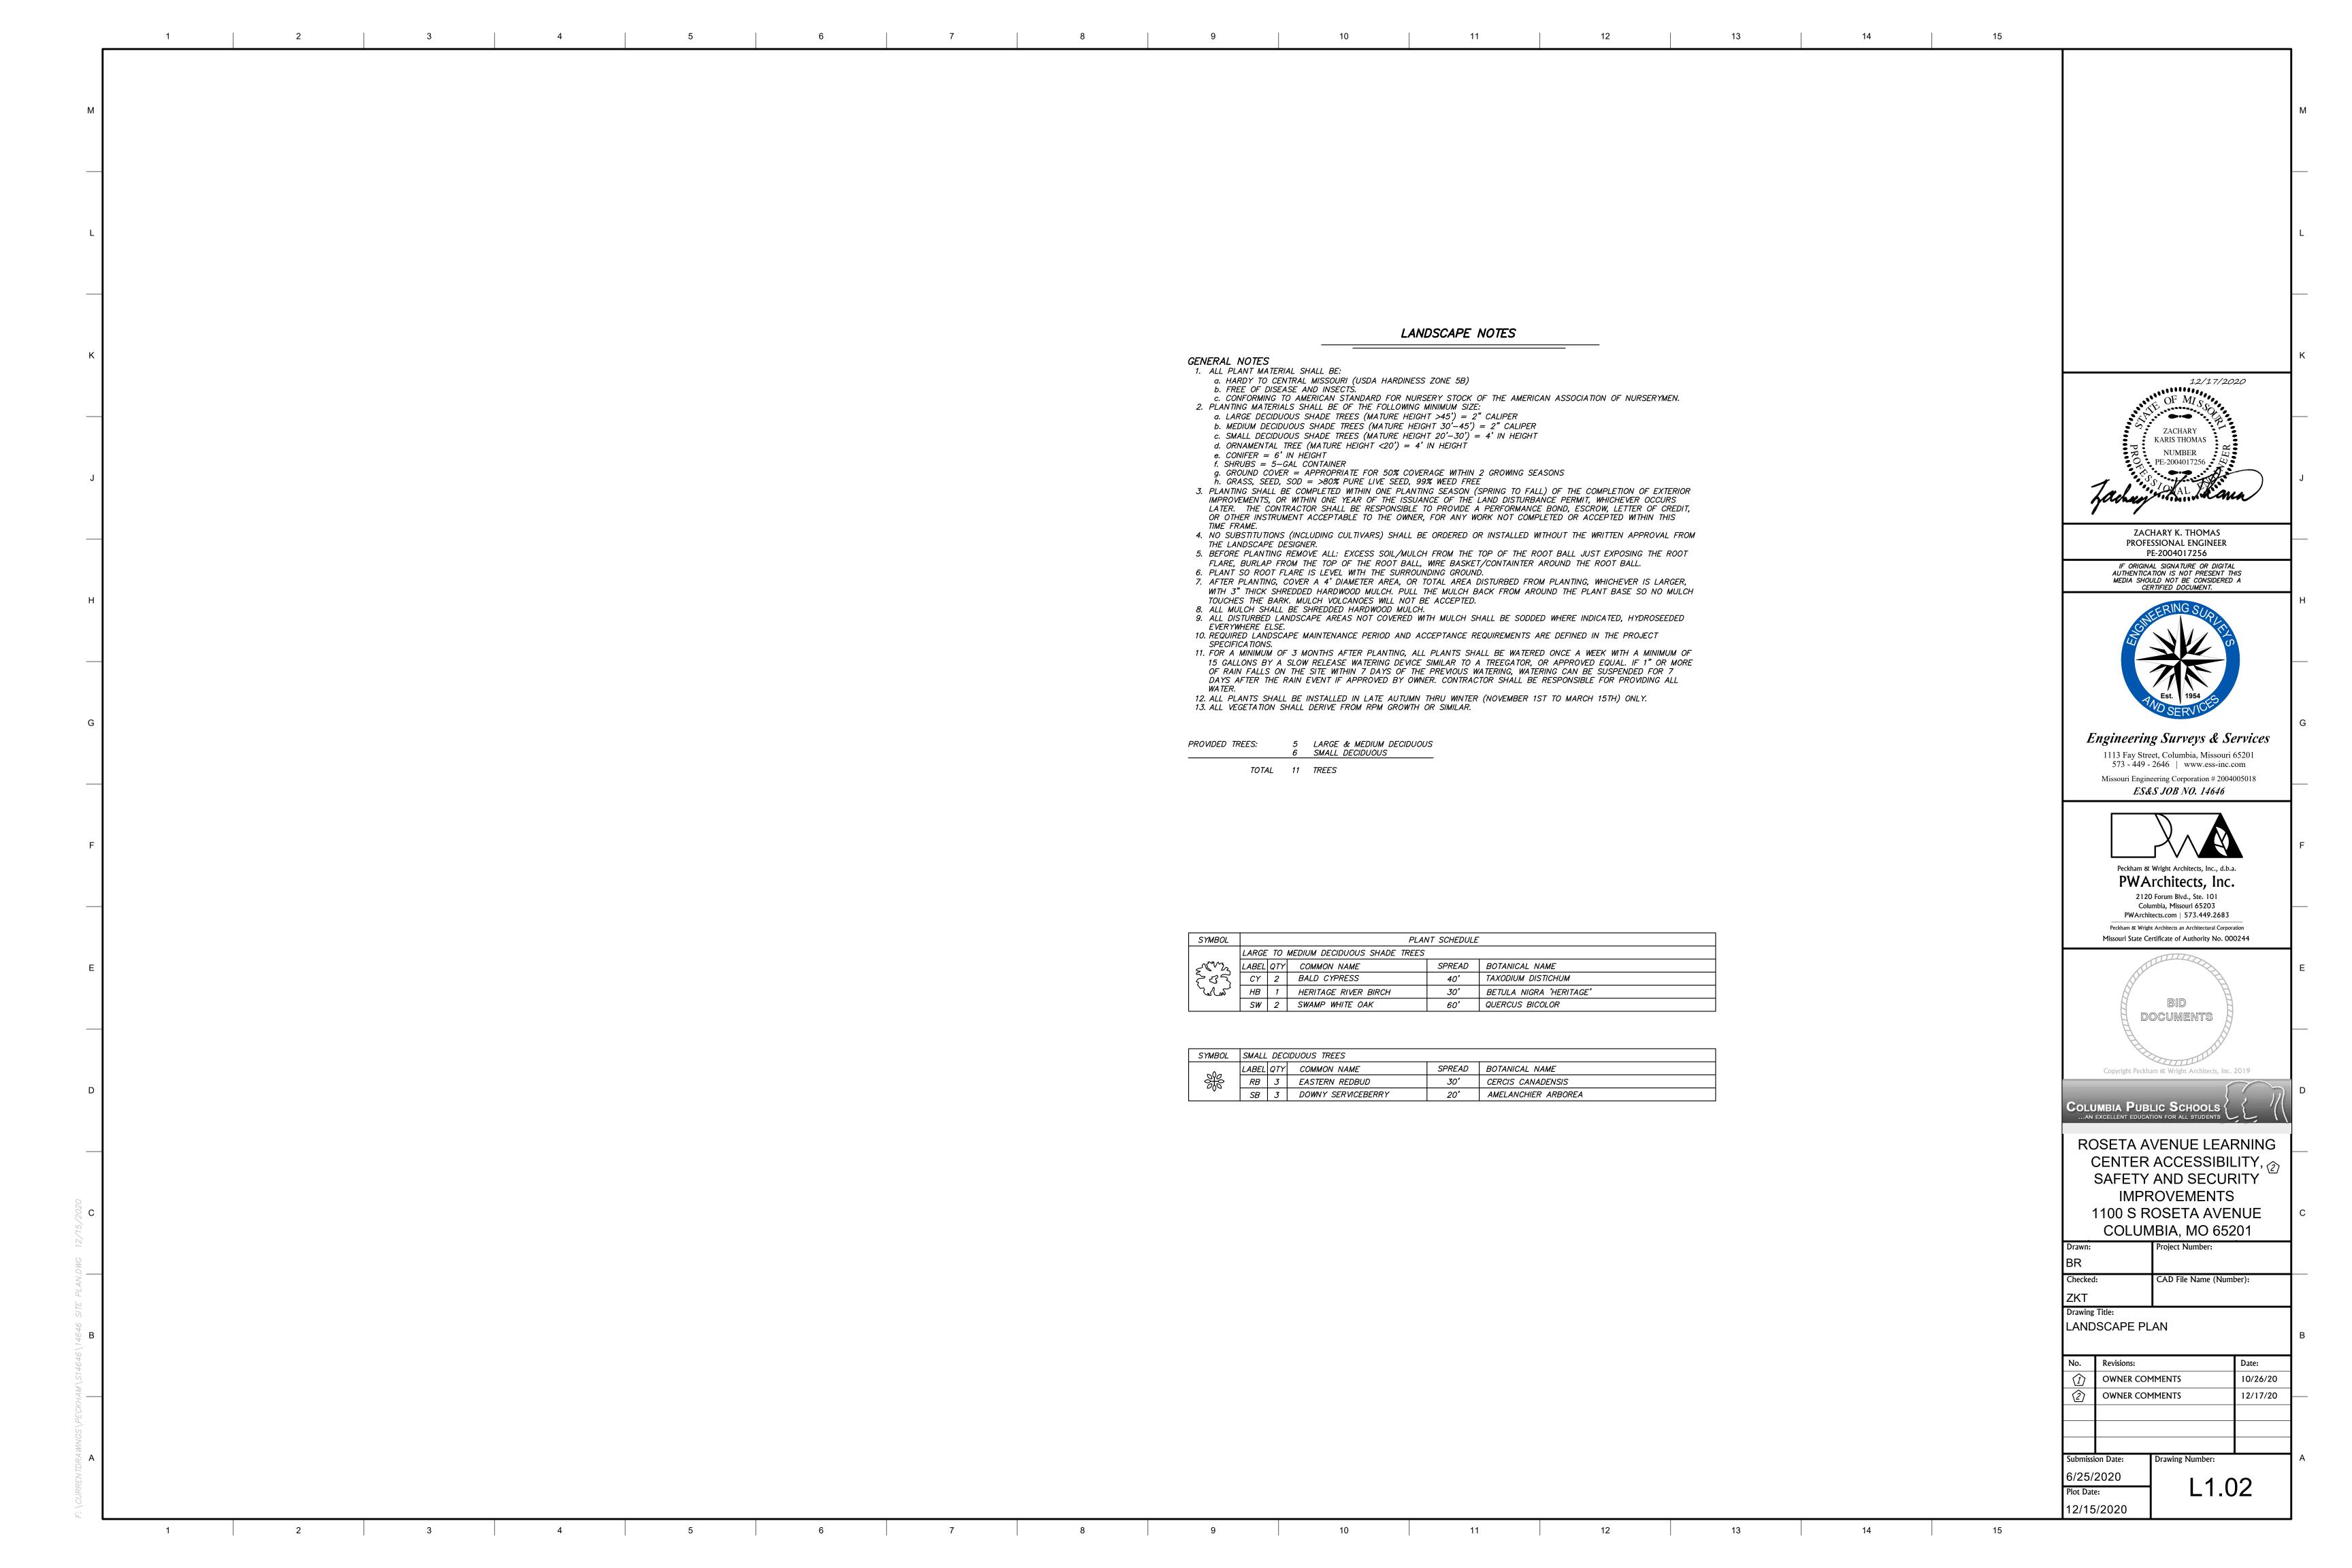

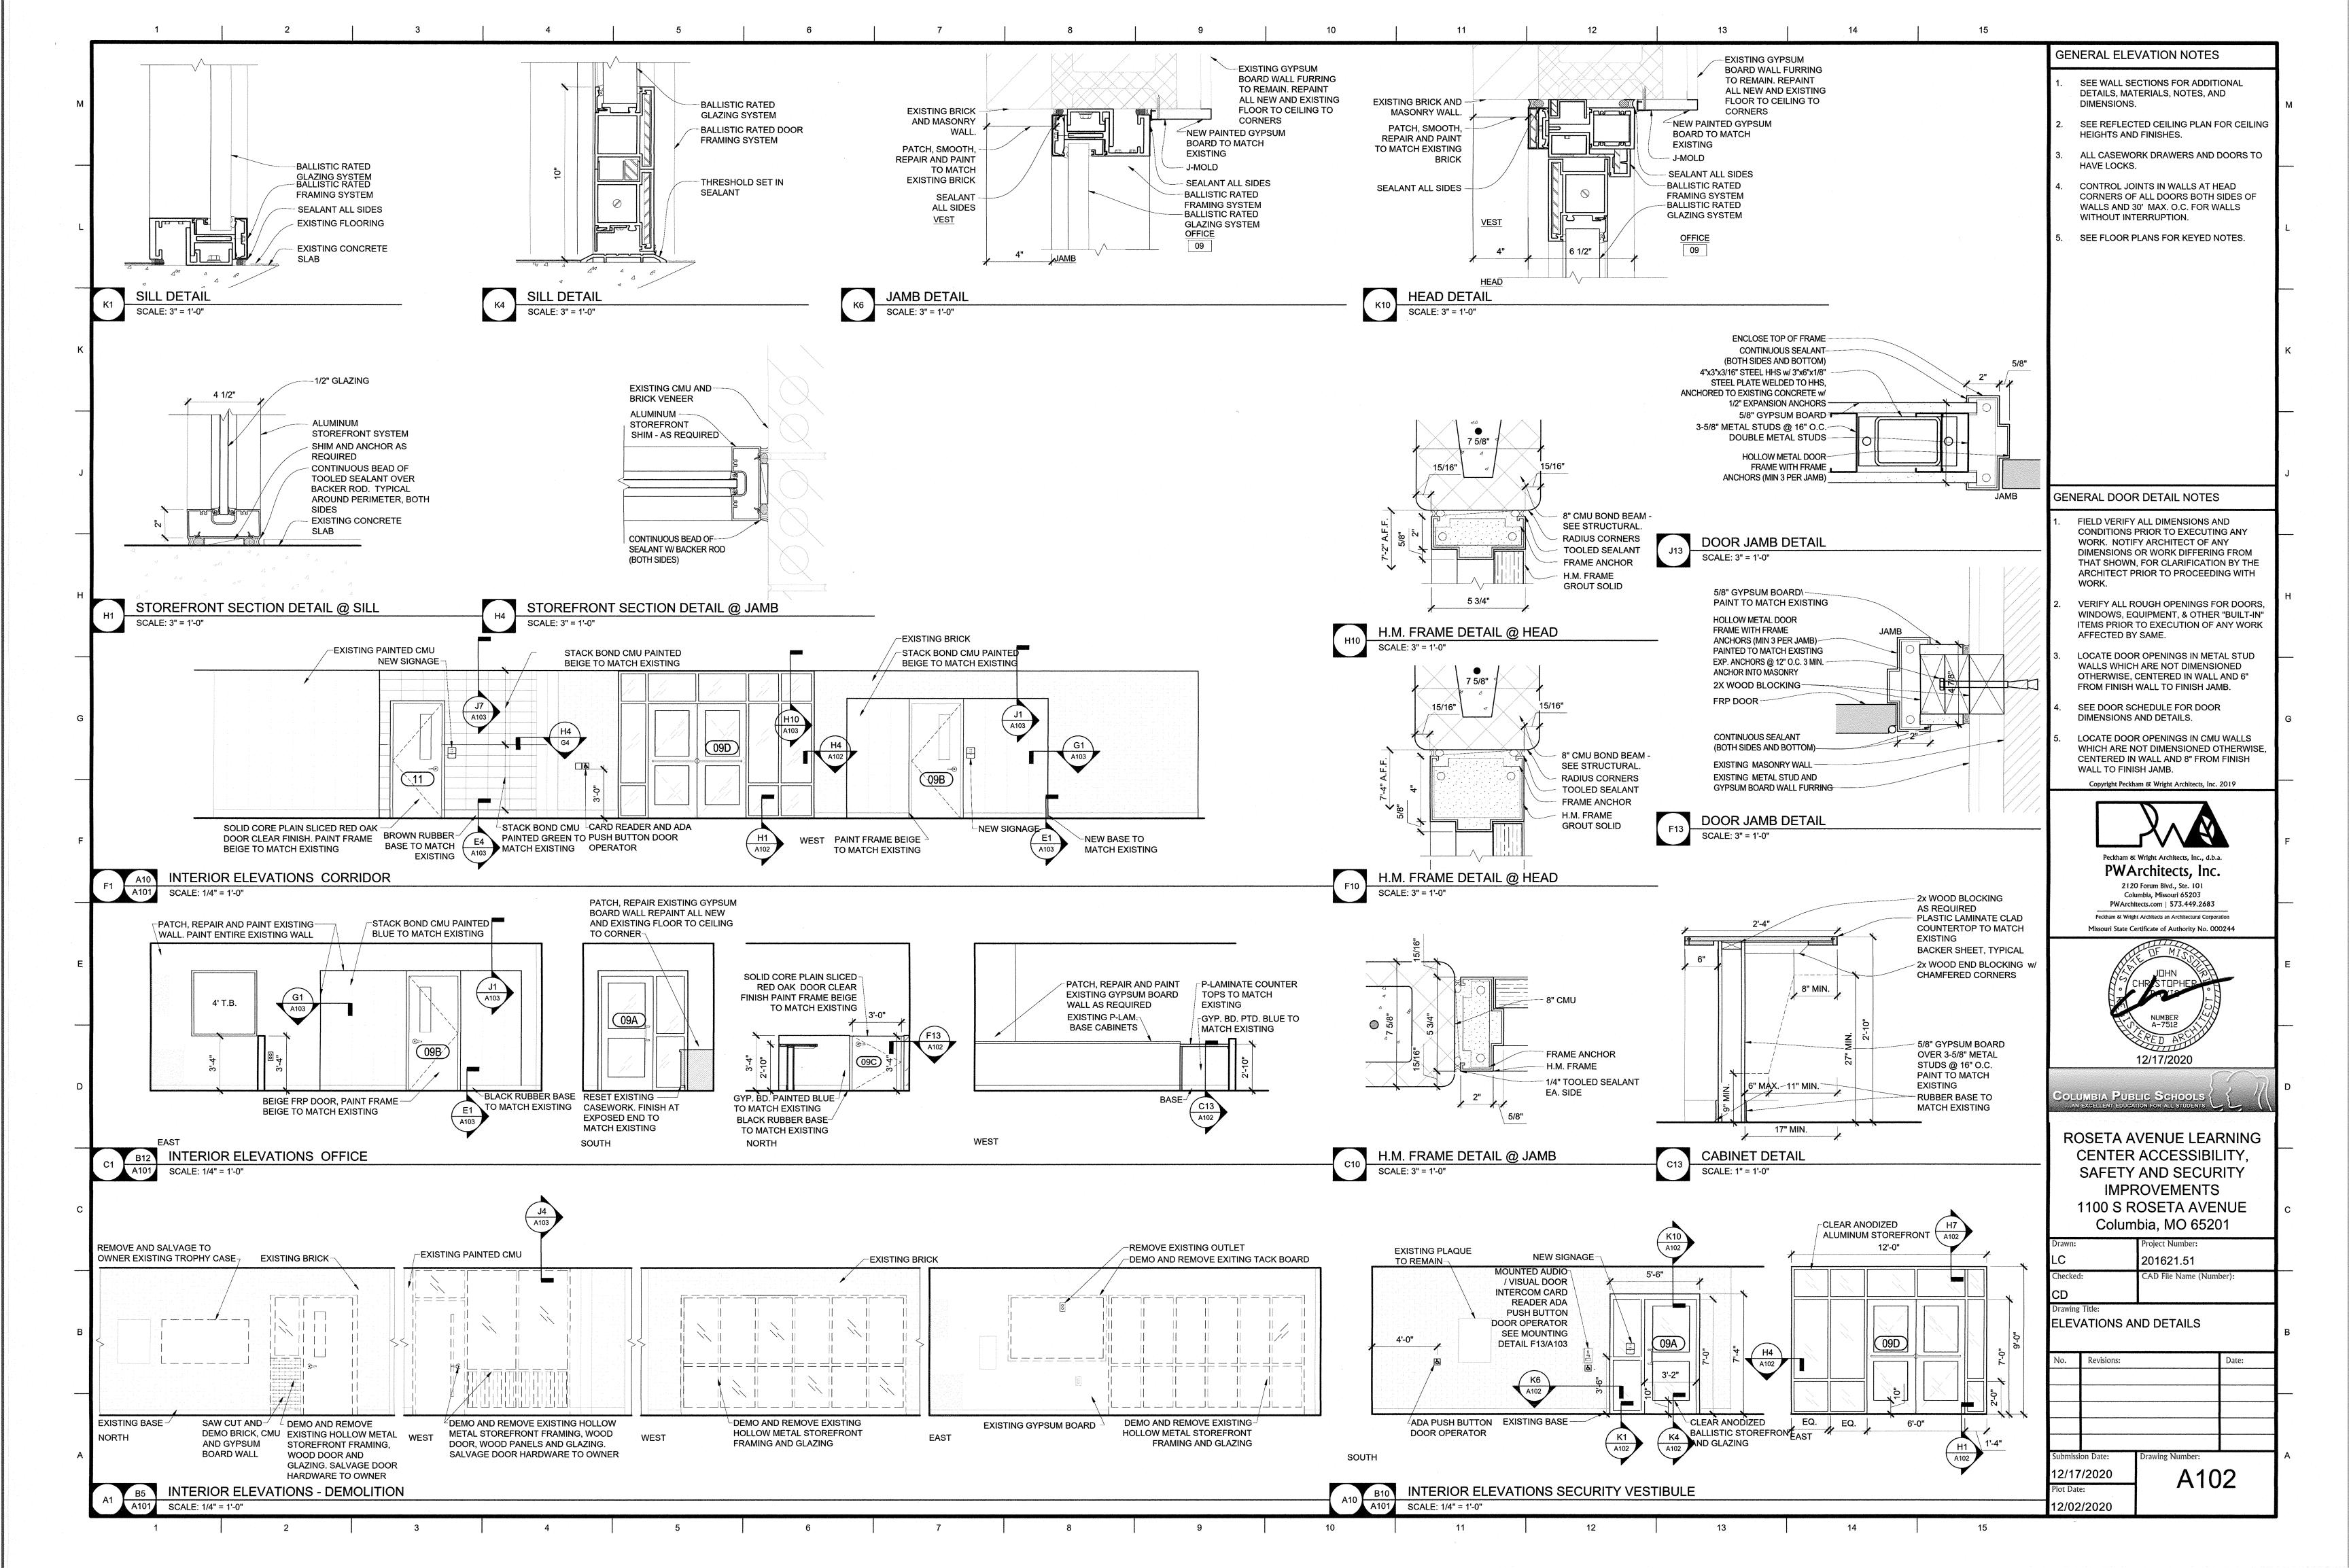

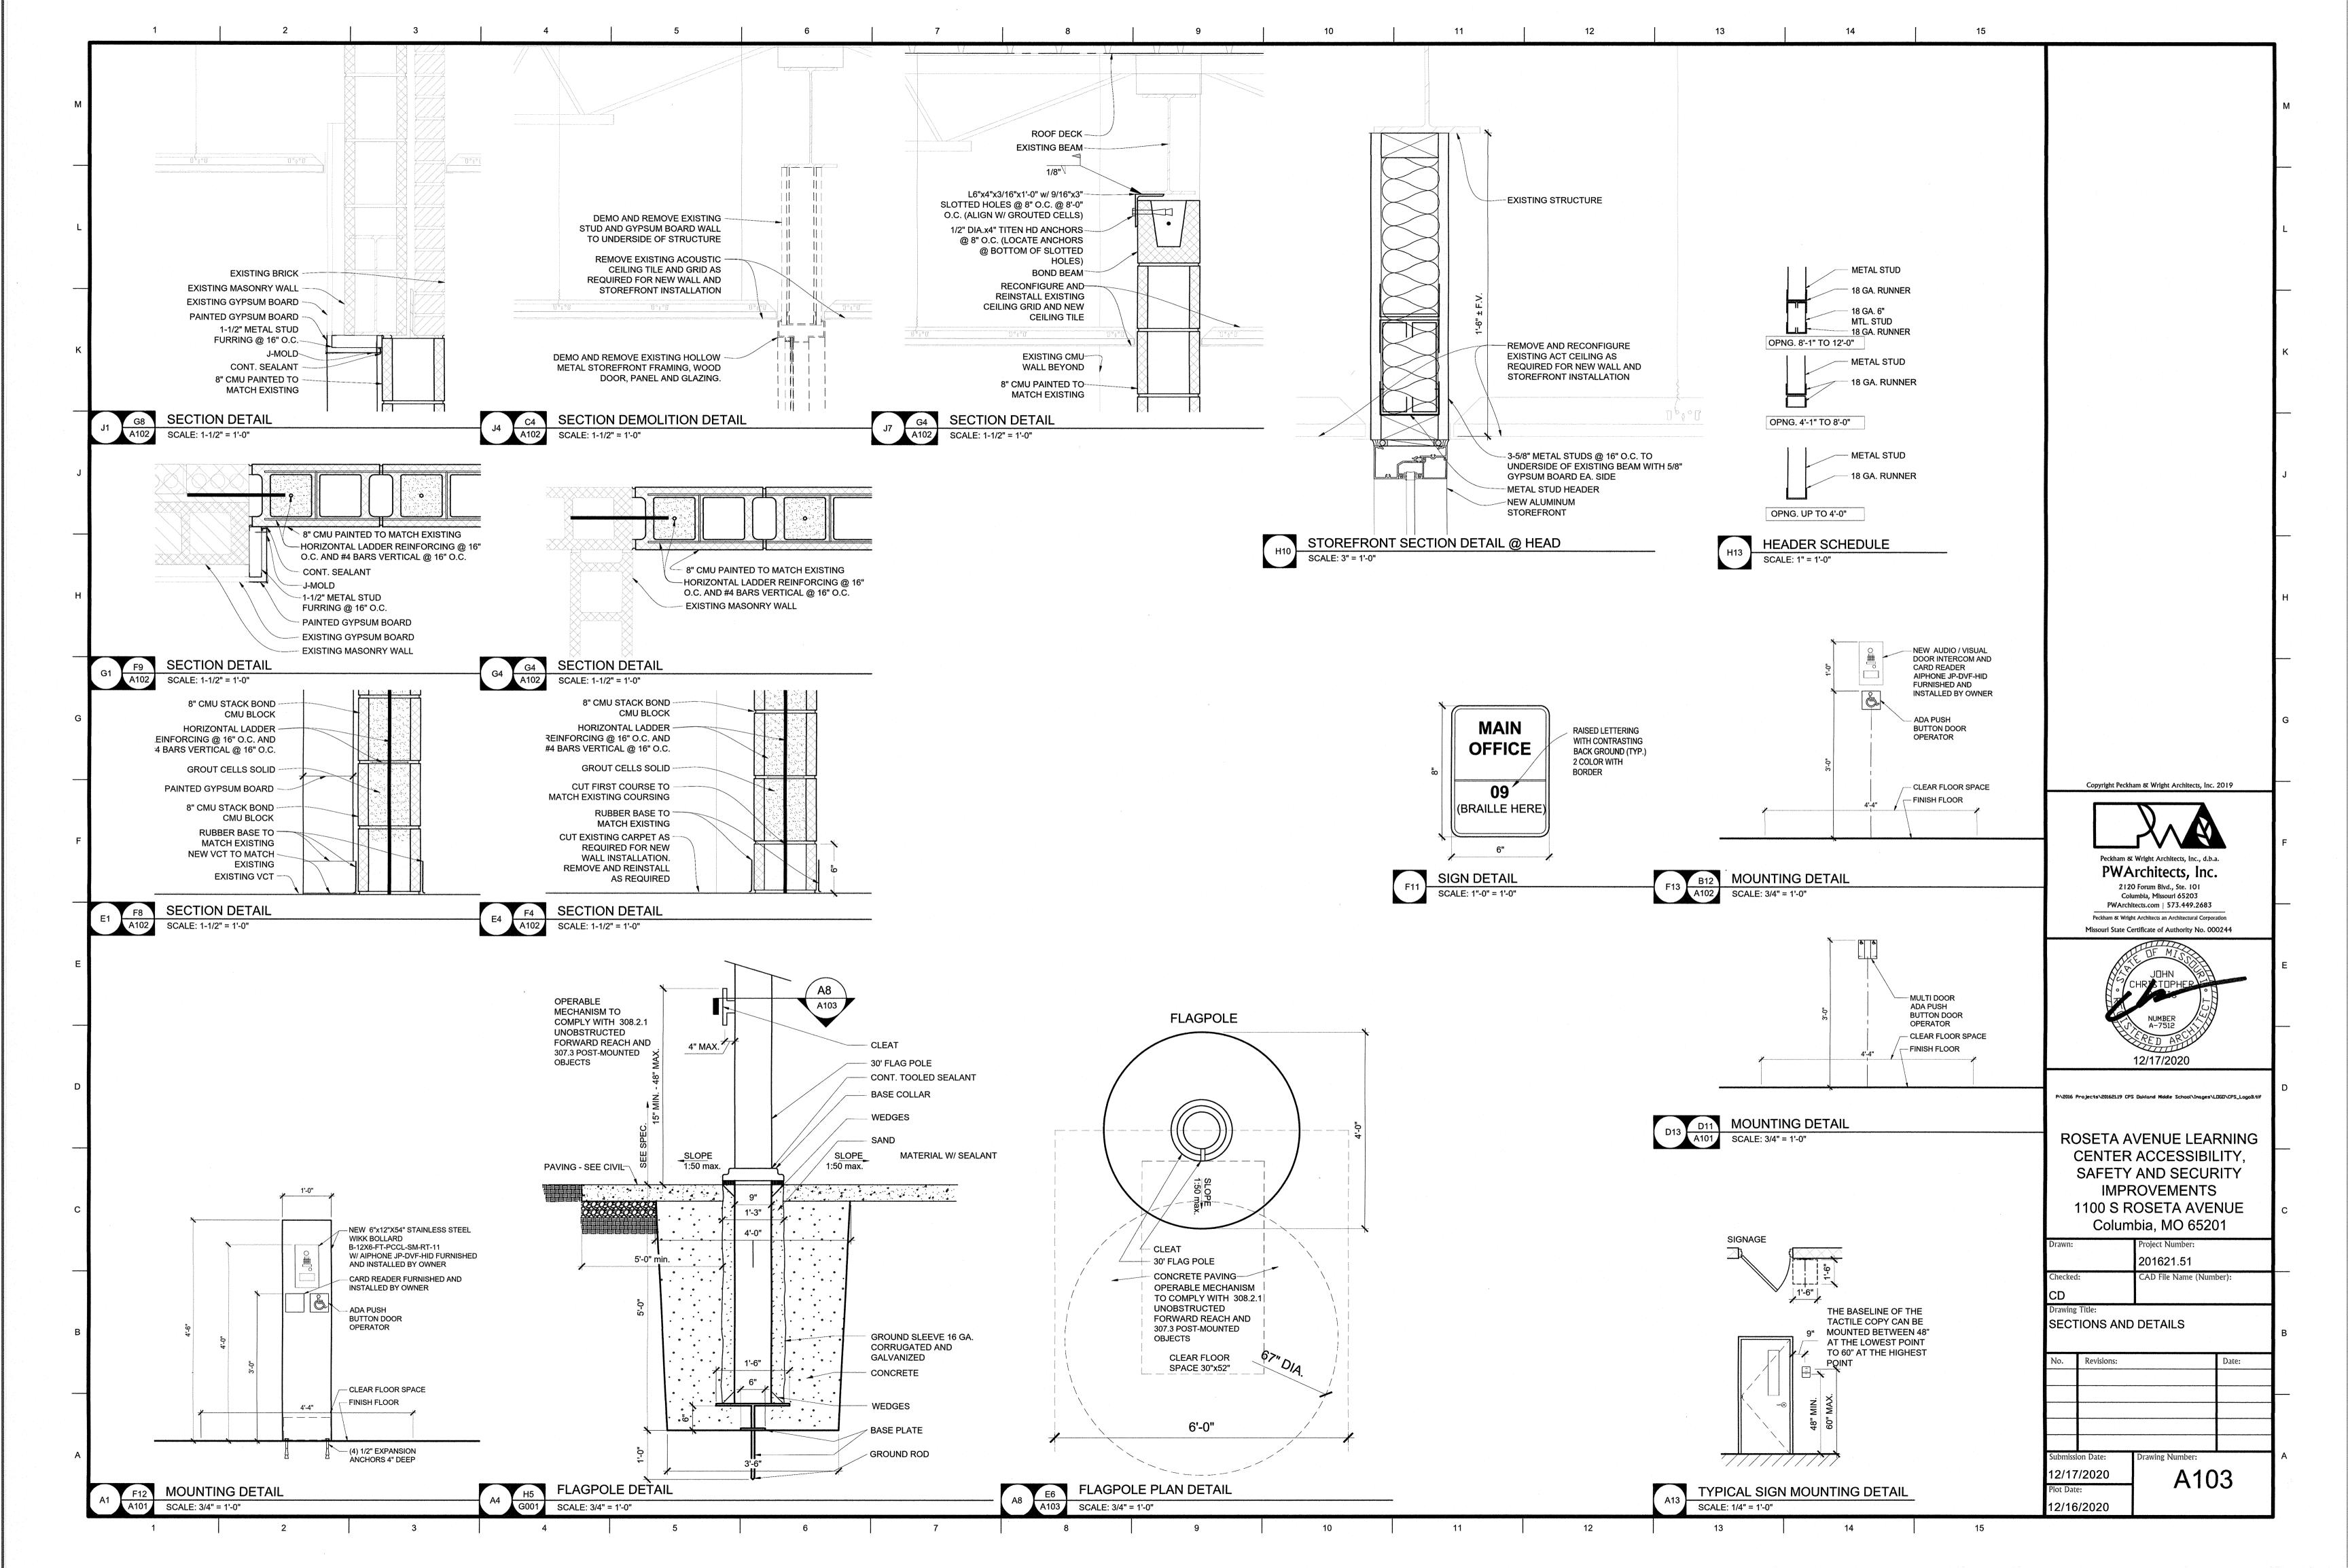

Mechanical-Electrical-Plumbing Drawings for ROSETA ACCESSIBILITY, SECURITY AND

SAFETY IMPROVEMENTS

1100 ROSETA AVE.
COLUMBIA, BOONE COUNTY, MO

GENERAL MECHANICAL-ELECTRICAL-PLUMBING SPECIFICATIONS

- ALL WORK SHALL BE DONE IN STRICT CONFORMANCE WITH THE LOCAL BUILDING CODES.
- 2. ALL MATERIALS SHALL BE NEW, FIRST CLASS, AND INSTALLED TO MANUFACTURER'S WRITTEN SPECIFICATIONS.
- 3. ALL SYSTEMS SHALL BE COMPLETE AND OPERABLE IN EVERY WAY.
- 4. DO ALL EXCAVATION, BACK FILLING, CUTTING, PATCHING, OFFSETTING, ADJUSTING, AND BALANCING AS REQUIRED TO
- 5. SPECIFIC MODELS ARE SPECIFIED TO ESTABLISH QUALITY ONLY. SUBSTITUTIONS MAY BE MADE WITH ENGINEER'S APPROVAL.
- 6. GUARANTEE ALL WORKMANSHIP AND MATERIALS FOR ONE YEAR FROM FINAL ACCEPTANCE. PROVIDE FIVE YEAR AIR CONDITIONING COMPRESSOR WARRANTY.
- 7. INSPECT JOB SITE PRIOR TO BIDDING TO DETERMINE EXACT JOB REQUIREMENTS. SEE ARCHITECTURAL DRAWINGS FOR CONSTRUCTION DETAILS
- 8. ARCHITECTURAL DRAWING DIMENSIONS SHALL GOVERN IN ALL CASES. COORDINATE ENGINEERING DRAWINGS WITH ARCHITECTURAL DRAWINGS FOR ALL EQUIPMENT LAYOUTS AND LOCATIONS.
- 9. LAYOUTS AND ROUTINGS SHOWN ON THE PLANS ARE APPROXIMATE AND GENERAL IN NATURE. CONTRACTORS ARE REQUIRED TO INSPECT THE JOBSITE FOR INTERFERENCES, OBSTRUCTIONS, AND CONFLICTS AND NOTIFY THE ENGINEER OF THE SAME, AND INCLUDE IN THEIR BID AND WORK SCOPE ALL ASSOCIATED COSTS TO MODIFY THE LAYOUTS AND ROUTINGS
- AS NECESSARY TO ACCOMMODATE THE INSTALLATION OF THEIR WORK AROUND SUCH INTERFERENCES, OBSTRUCTIONS, AND CONFLICTS.

 10. CONTRACTOR IS TO INCLUDE COSTS FOR ALL PERMITS, INSPECTIONS, TAPS, METERS & FUEL ASSOCIATED WITH HIS WORK.

 11. CONTRACTOR IS RESPONSIBLE FOR REVIEWING AND UNDERSTANDING ALL DRAWINGS AND ASPECTS OF THE PROJECT

SCOPE, AND FOR INCLUDING IN HIS BID ALL WORK ASSOCIATED WITH HIS TRADE, REGARDLESS OF WHICH DRAWING OR

FIRE PENETRATION NOTE

SHEET IT IS SHOWN ON.

THIS PROJECT CONTAINS FIRE RATED ASSEMBLIES. LOCATIONS ARE INDICATED ON ARCHITECTURAL PLANS. ALL CONTRACTORS SHALL PROVIDE PROTECTION FOR THEIR PENETRATIONS THRU THESE ASSEMBLIES AS FOLLOWS.

FOR ALL PENETRATIONS THRU OR INTO FIRE RATED VERTICAL OR HORIZONTAL ASSEMBLIES:

- A UL LISTED PENETRATION FIRESTOP SYSTEM SHALL BE INSTALLED AS TESTED IN ACCORDANCE WITH ASTM E814 OR
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- GENERAL CONTRACTOR TO PROVIDE AND MAINTAIN A BOOK WITH ALL FIRE PENETRATION PROTECTIVE SYSTEMS THAT WILL BE USED ON THIS PROJECT. THIS BOOK MUST REMAIN ON SITE AT ALL TIMES.

E	BASED ON THE FOLLOWING CODES
2015	INTERNATIONAL MECHANICAL CODE
2015	INTERNATIONAL PLUMBING CODE
2015	INTERNATIONAL FUEL GAS CODE
2015	INTERNATIONAL FIRE CODE
2014	NATIONAL ELECTRIC CODE
2015	INTERNATIONAL ENERGY CONSERVATION CODE

PLENUM SPACE NOTE		
THIS PROJECT INCLUDES A PLENUM SPACE		

- EMT CONDUIT, CAST IRON SANITARY & VENT PIPING
SEE EACH SHEET FOR SPECIFIC PLENUM NOTES

CONTRACTORS SHALL USE NON COMBUSTIBLE OR PLENUM RATED MATERIALS ABOVE CEILING:

SHEET INDEX			
SHEET#	SHEET NAME		
MEP1	MECHANICAL ELECTRICAL PLUMBING COVER SHEET		
MEP2	SITE UTILITIES PLAN		
MEP2.1	SITE UTILITIES DETAILS AND SCHEDULES		
MEP3	SITE PHOTOMETRIC PLAN		
EP100	POWER PLAN		
EL100	LIGHTING PLAN		





A Custom Engineering Company

912 OLD 63 SOUTH (573) 875-4365

PROFESSIONAL ENGINEER'S SEAL ON THIS DRAWING AFFIXED IN ACCORDANCE WITH THE REQUIREMEN' PTER 327, RSMO. IN AFFIXING THIS SEAL THE ENGII

SHANE L.
FLOYD

NUMBER
PE-2019017814

DECEMBER 17TH, 202

SHANE FLOYD, P.E. PE-2019017814

CERTIFICATE OF AUTHORITY

TO OFFER ENGINEERING SERVICES

TIMBERLAKE ENGINEERING, PC

CERTIFICATE OF AUTHORITY #: 2006012388



ROSETA AVENUE LEARNING CENTER ACCESSIBILITY, SAFETY AND SECURITY IMPROVEMENTS 1100 S ROSETA AVENUE


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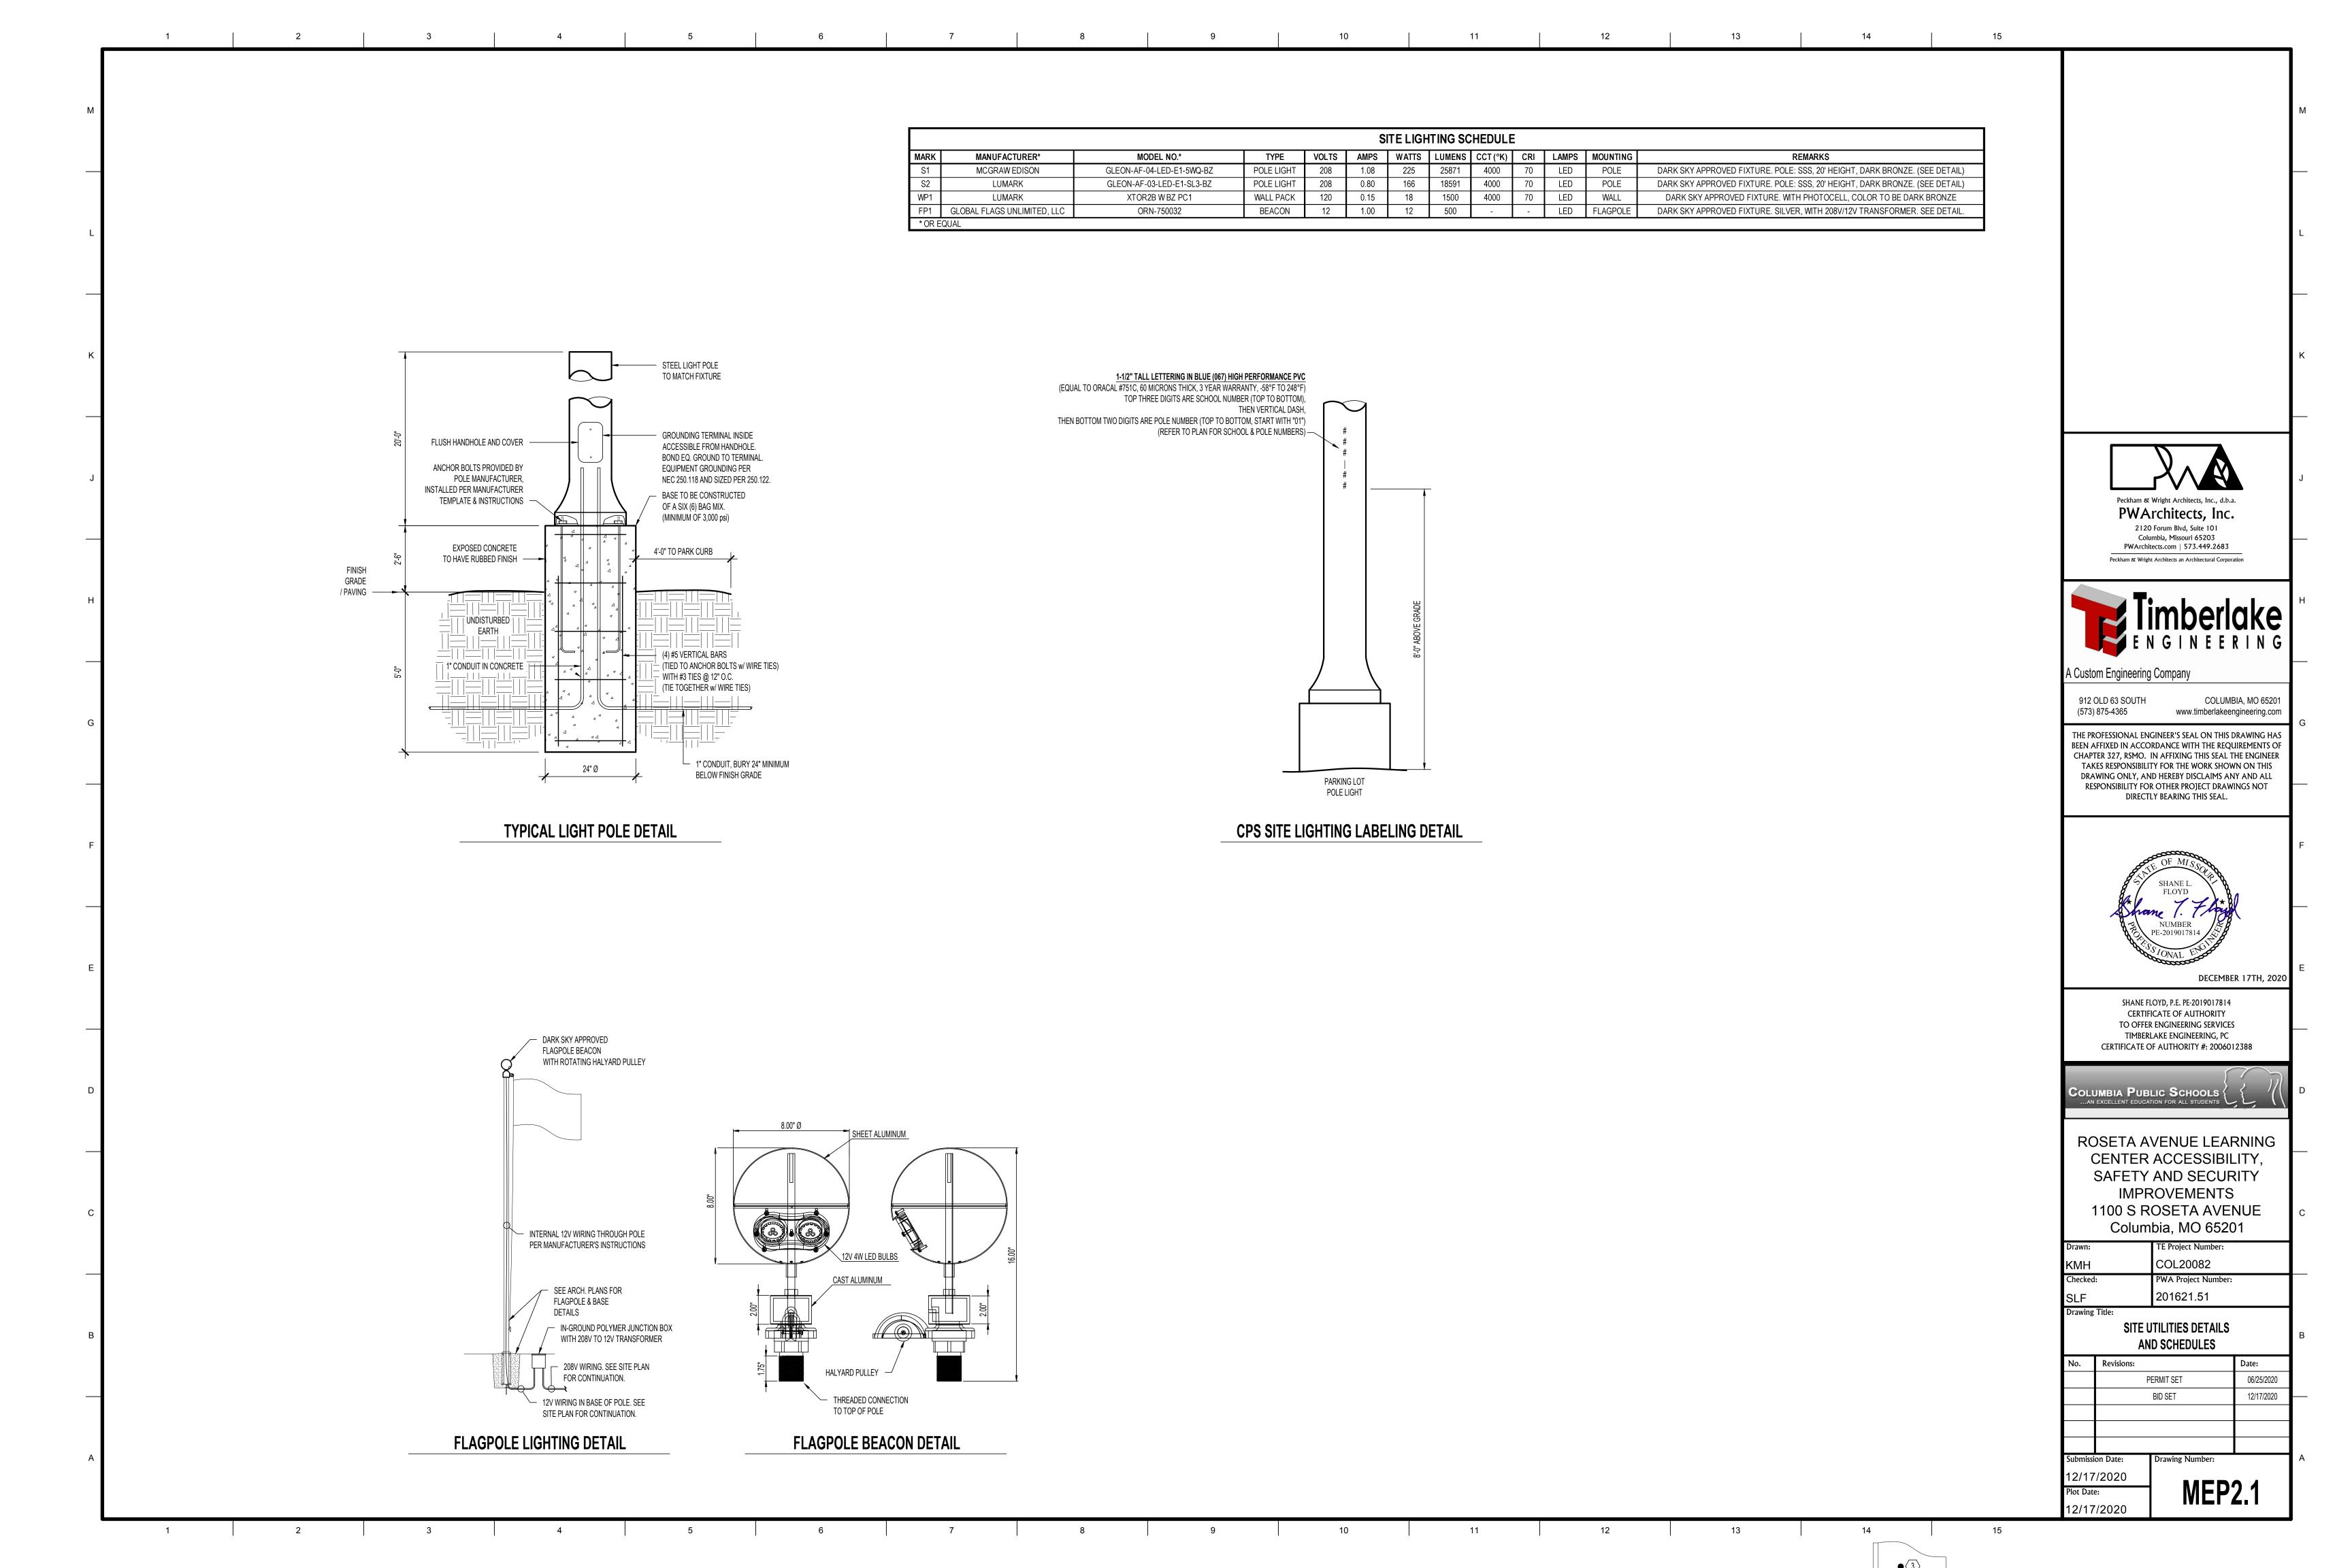
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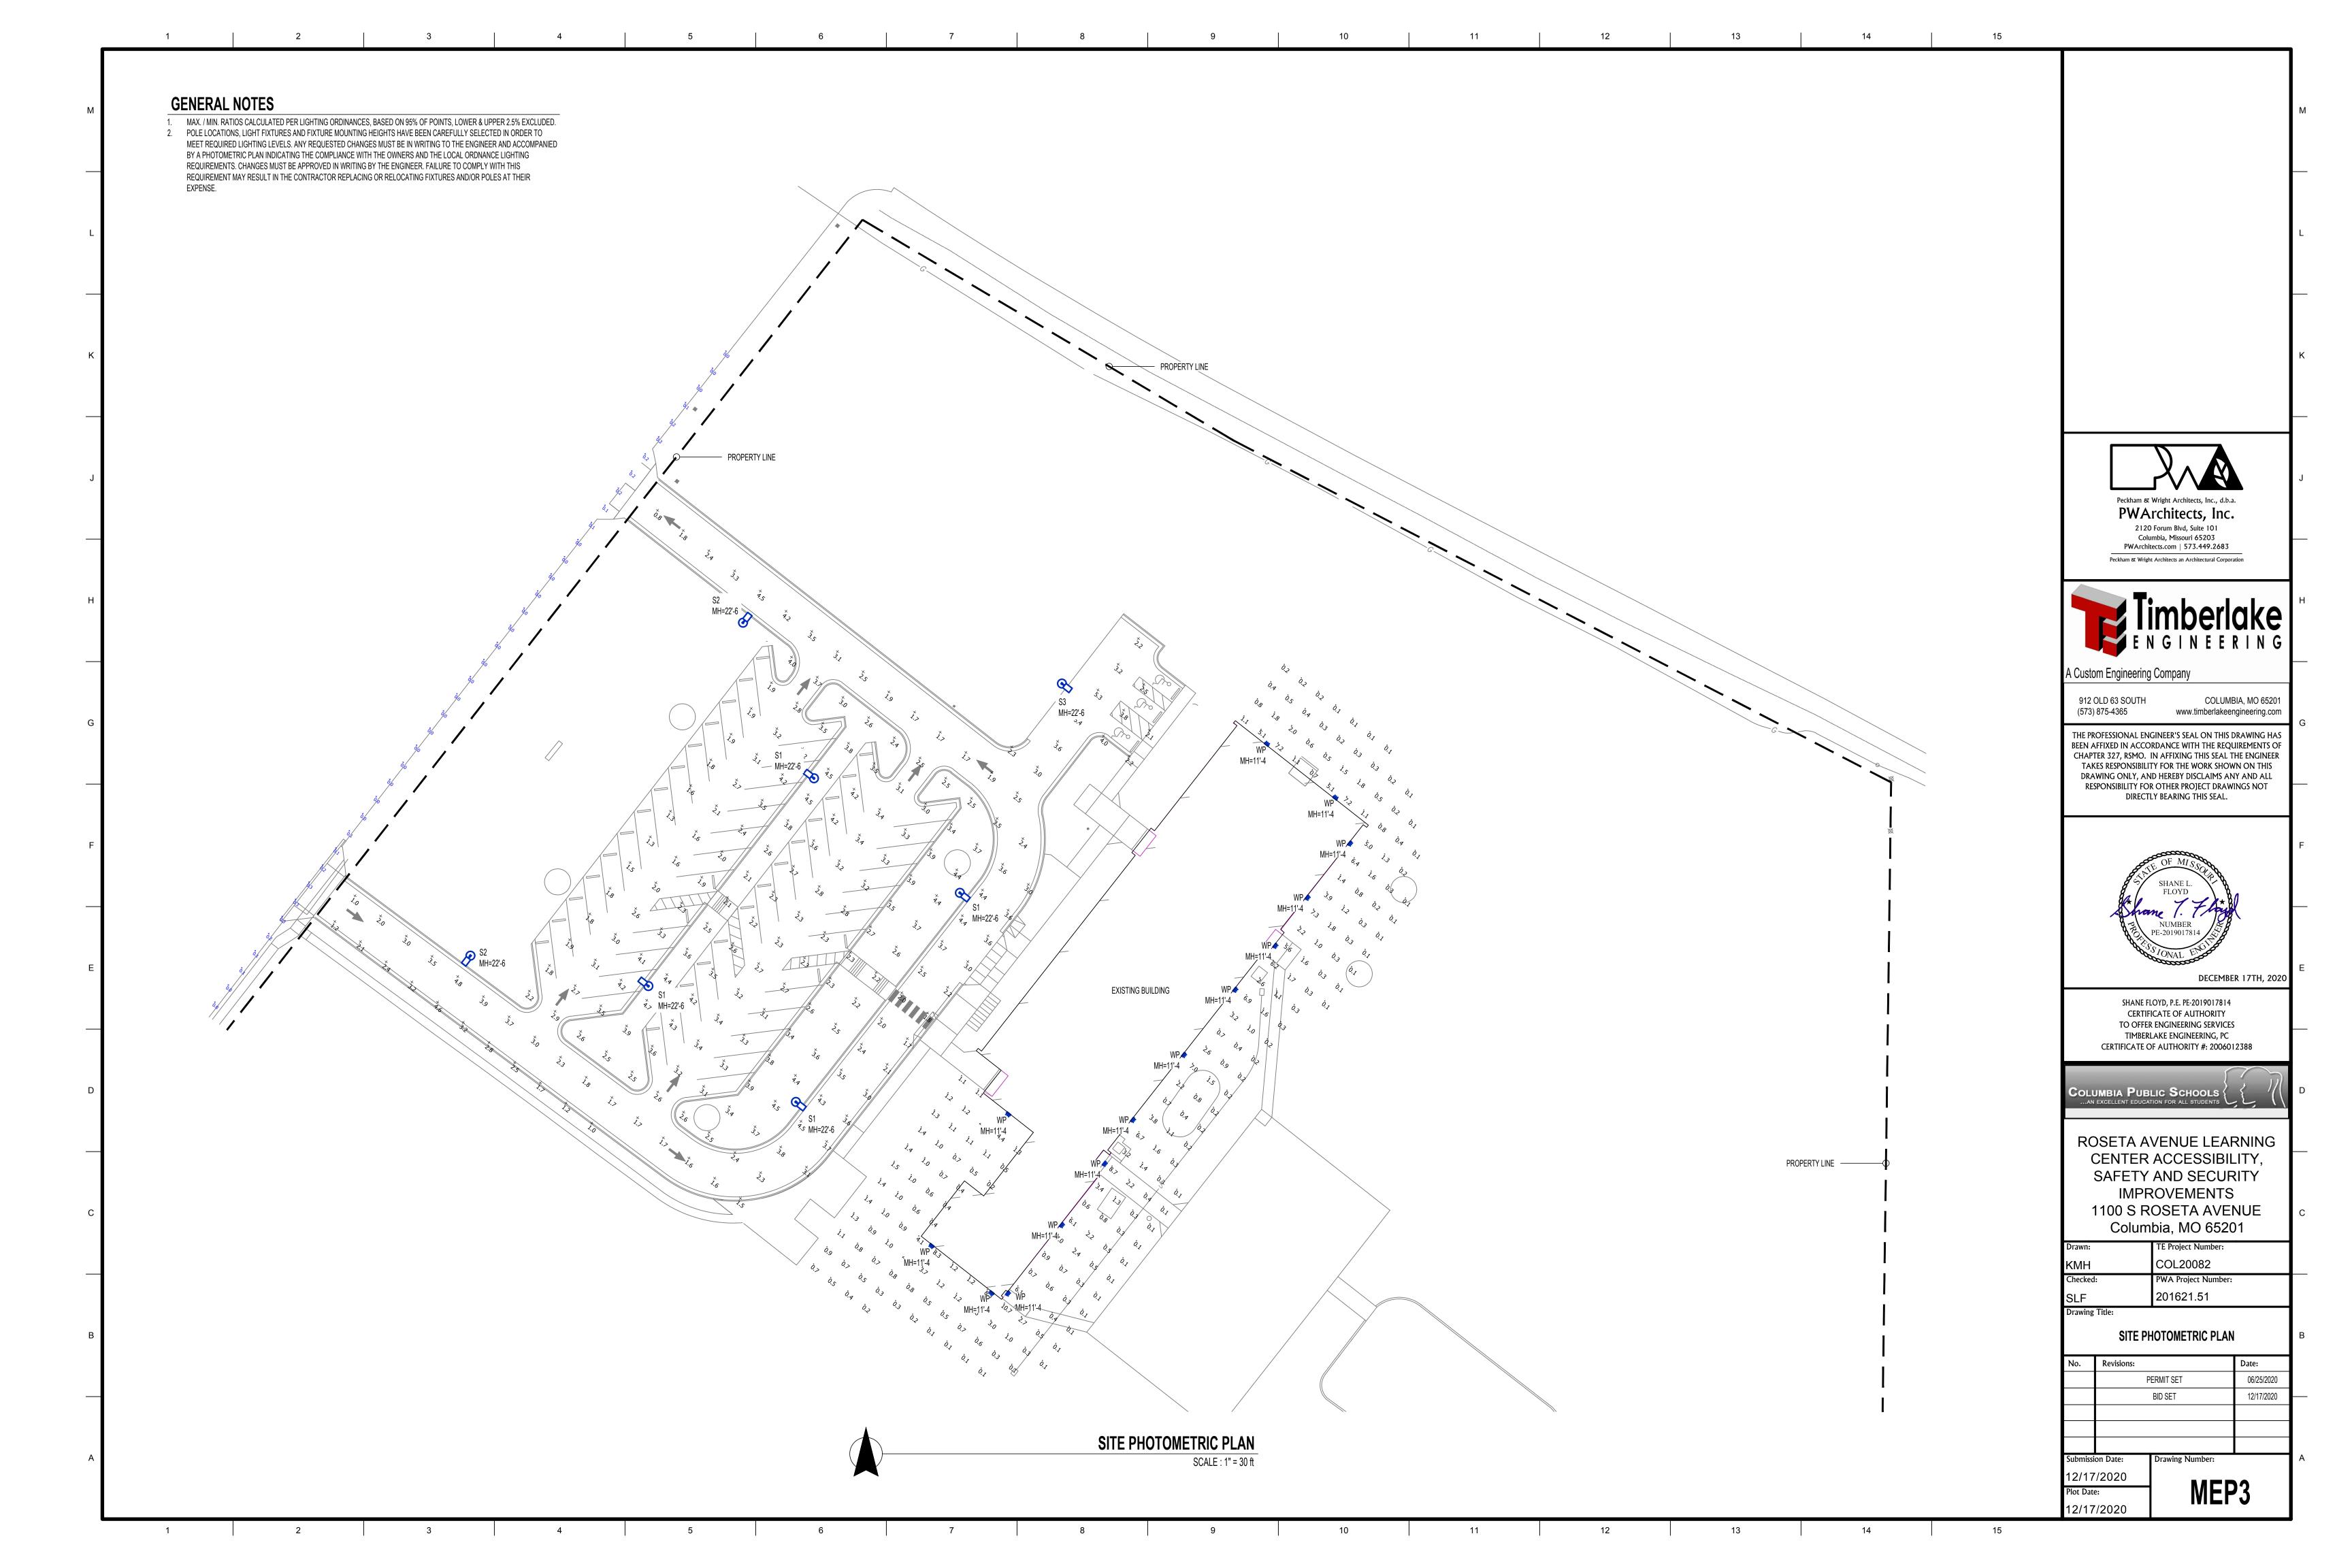
MECHANICAL ELECTRICAL
PLUMBING COVER SHEET


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		PERMIT SET	06/25/2020
		BID SET	12/17/2020
Submiss	sion Date:	Drawing Number:	

12/17/2020
Plot Date:
12/17/2020





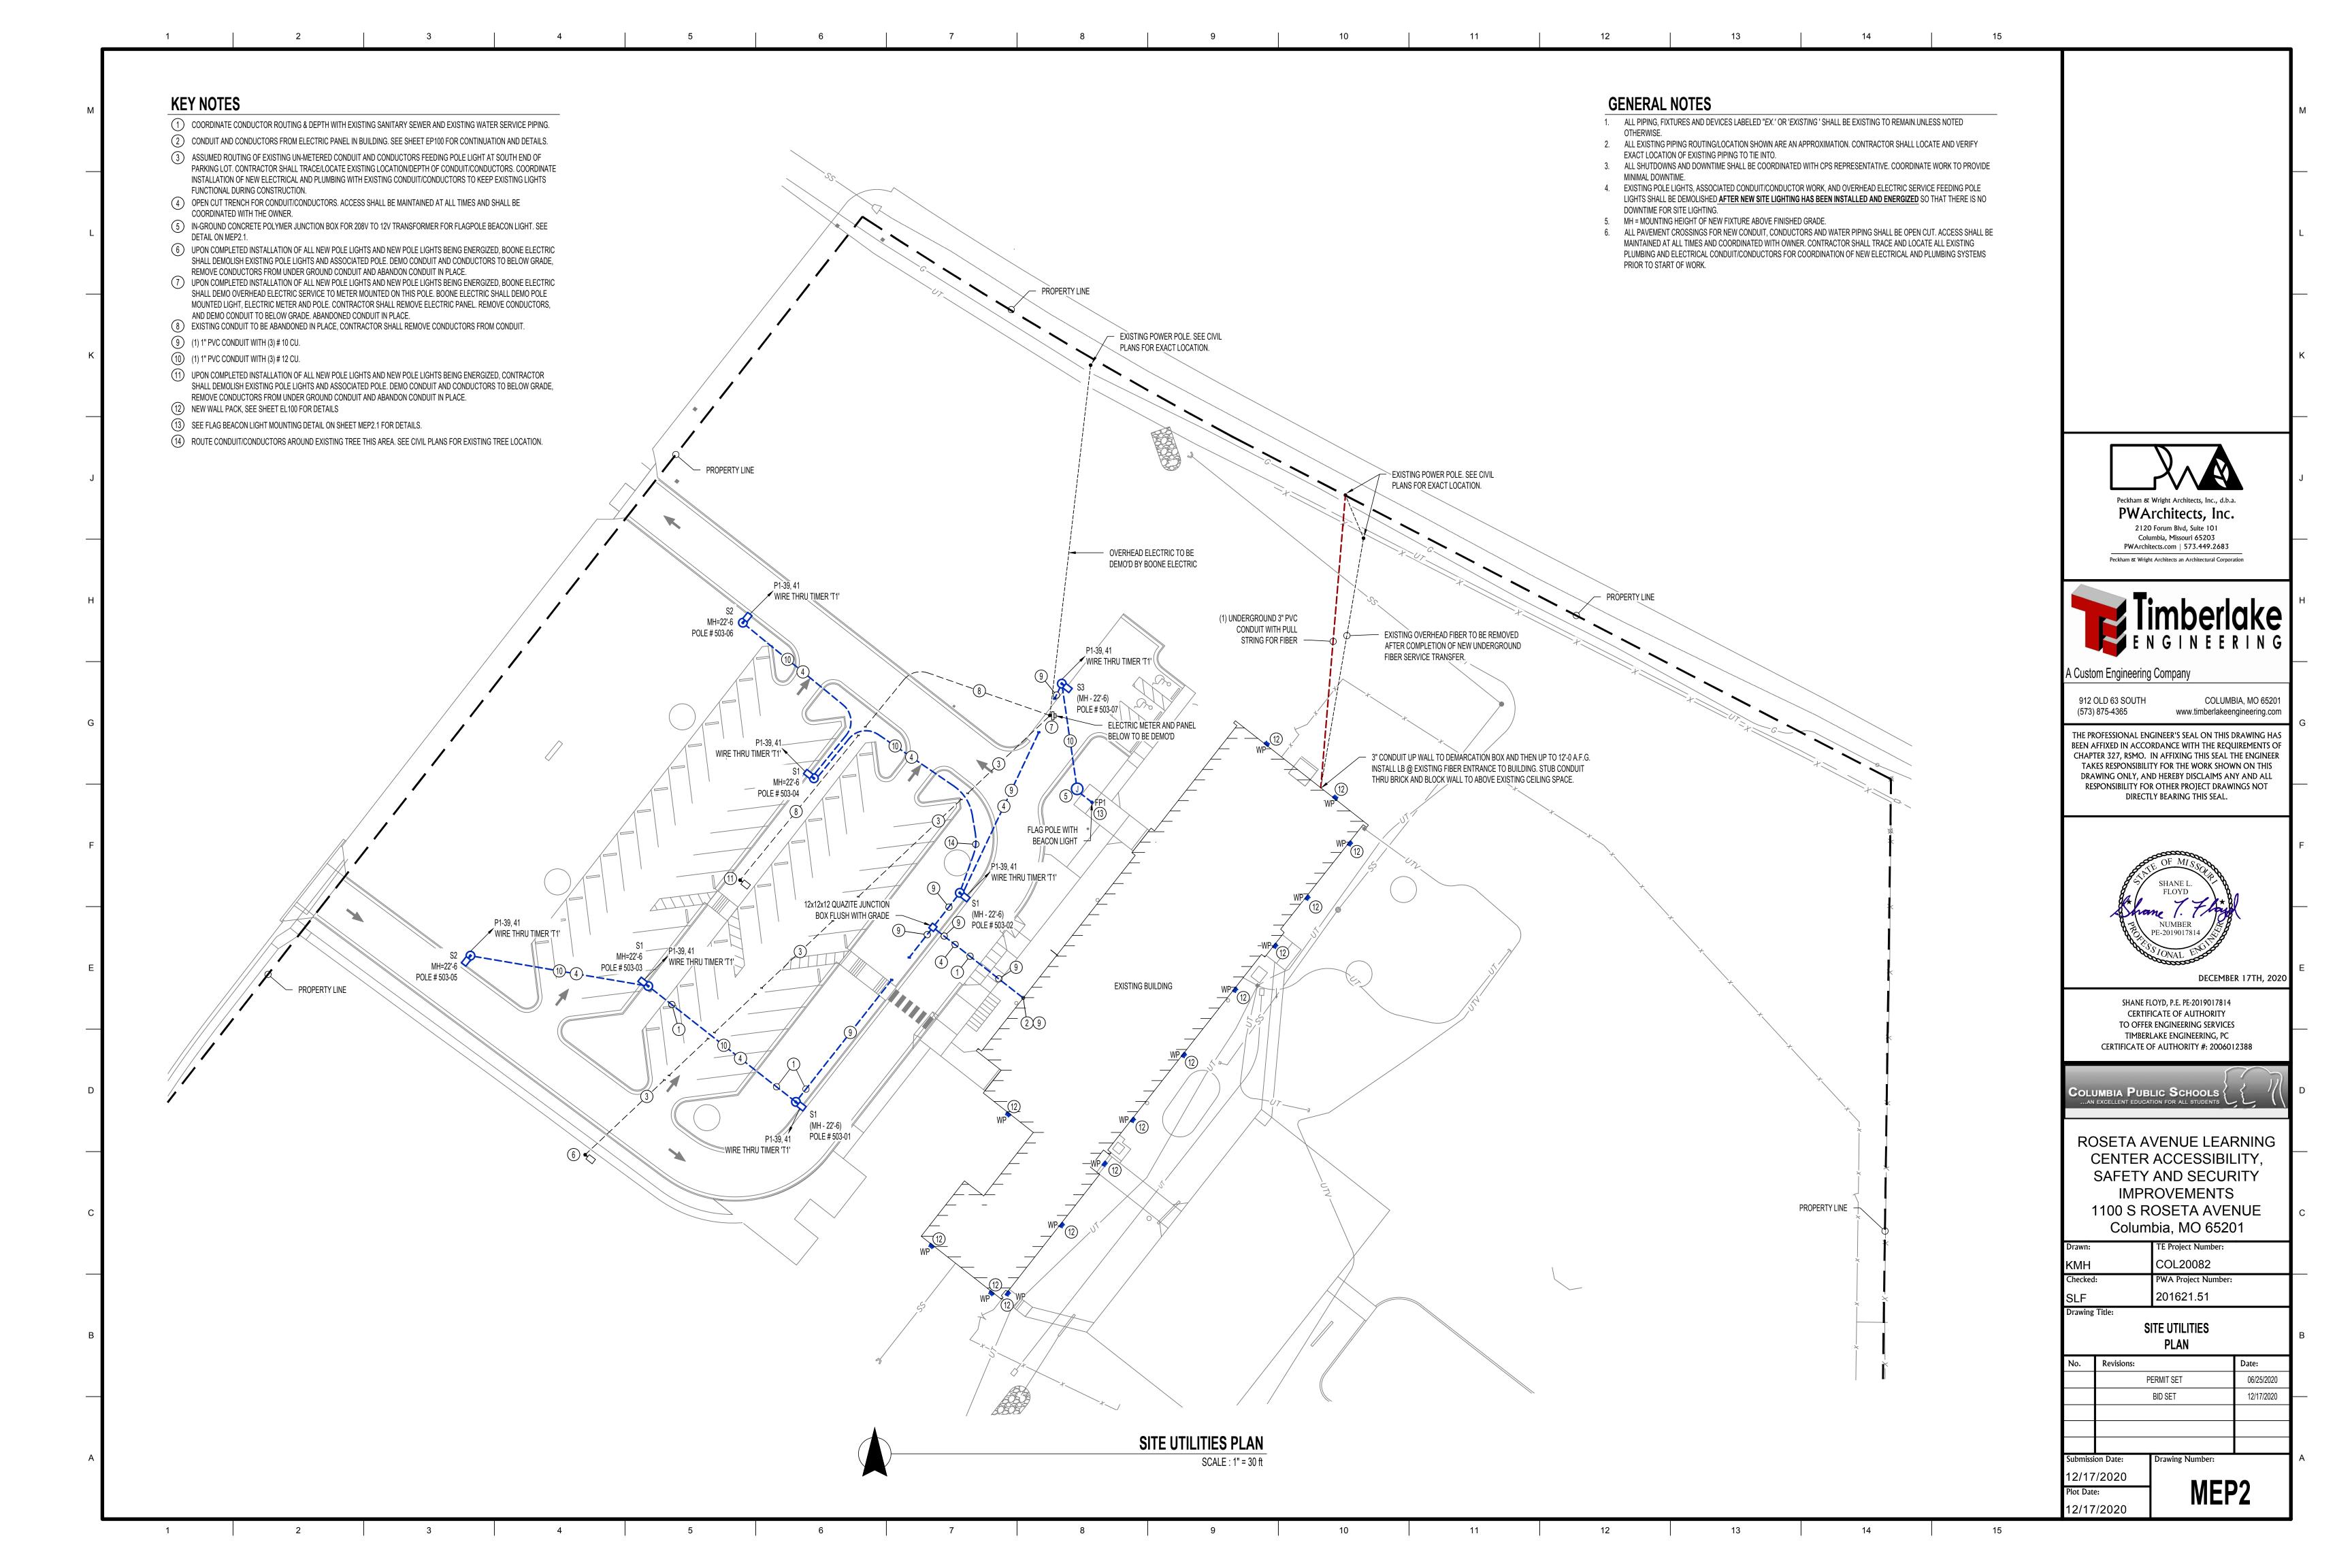

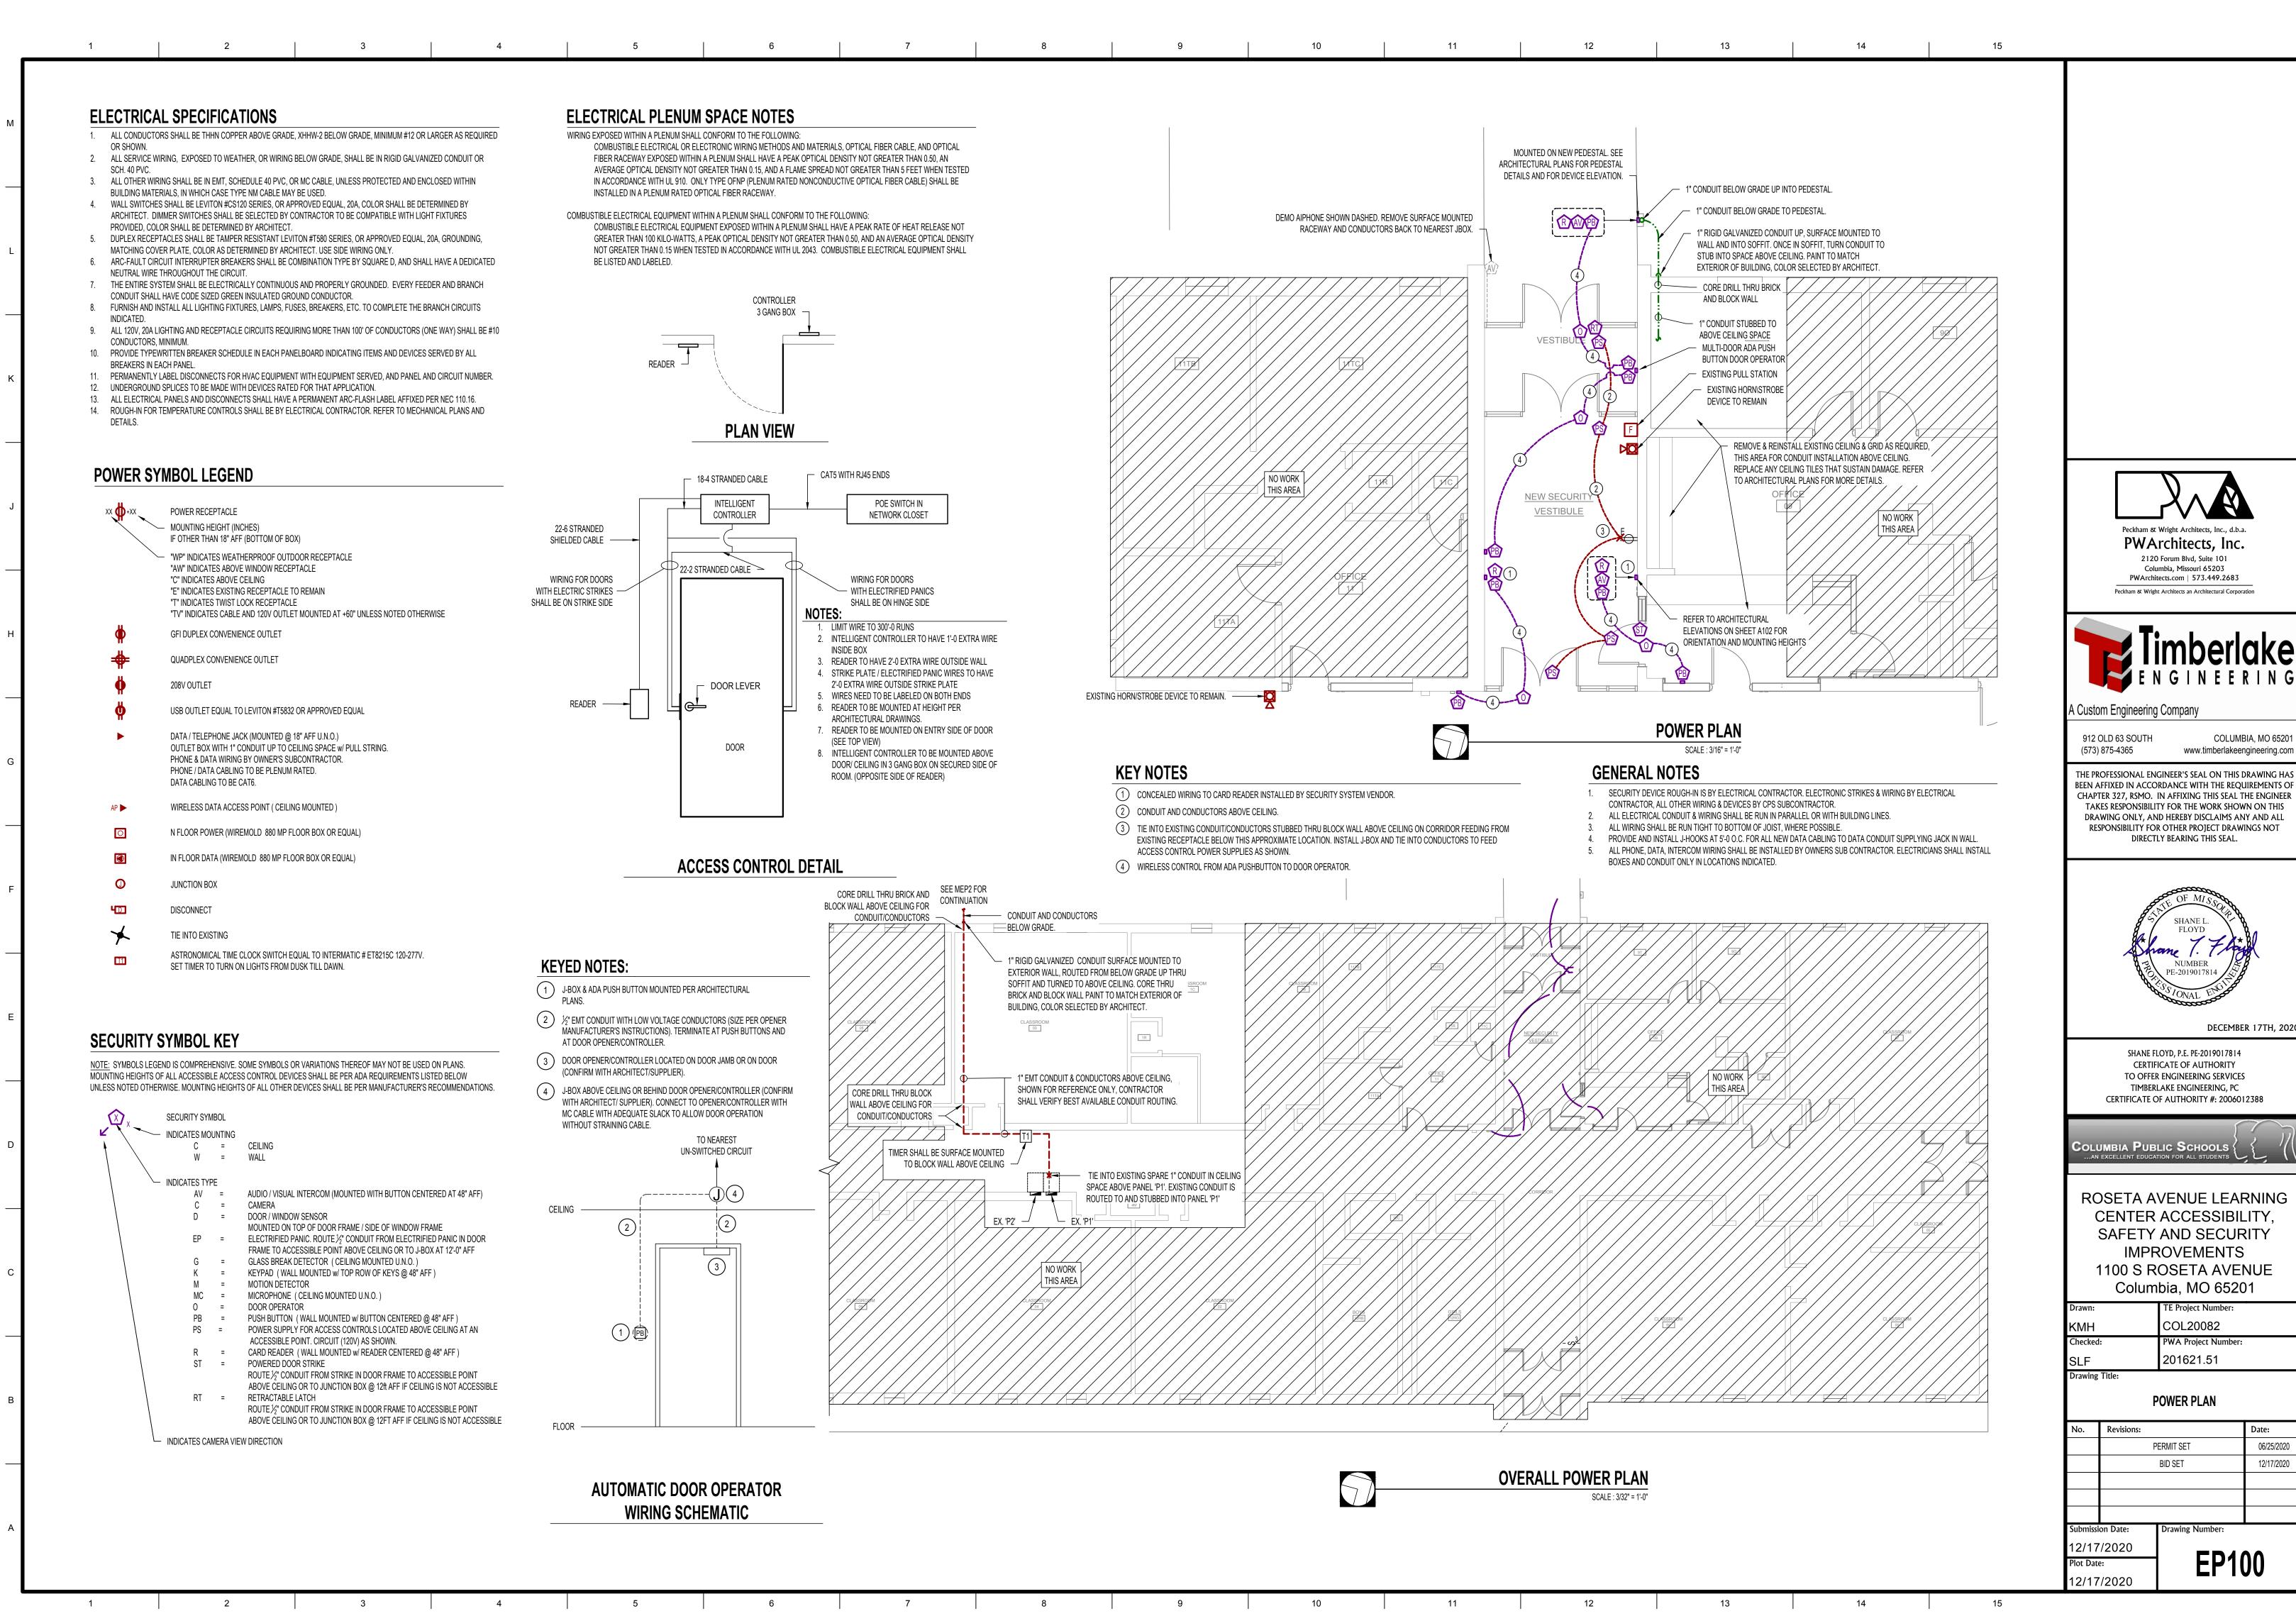

Peckham & Wright Architects, Inc., d.b.a.

PWArchitects, Inc.

2120 Forum Blvd, Suite 101

Columbia, Missouri 65203 PWArchitects.com | 573.449.2683

DIRECTLY BEARING THIS SEAL.

SHANE FLOYD, P.E. PE-2019017814

CERTIFICATE OF AUTHORITY

TO OFFER ENGINEERING SERVICES

TIMBERLAKE ENGINEERING, PC

TE Project Number:

PWA Project Number:

06/25/2020 12/17/2020

COL20082

201621.51

POWER PLAN

PERMIT SET

BID SET

COLUMBIA, MO 65201

DECEMBER 17TH, 2020

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